

## Village of Silverton – Planning Commission Agenda

Wednesday, July 17 – 5:00 PM 6943 Montgomery Road Silverton, Ohio 45236

#### 1. OPEN THE MEETING

- a. Moment of Silence
- b. Pledge of Allegiance
- 2. ROLL CALL

#### 3. REVIEW AND APPROVAL OF MINUTES

a. May 22, 2024

#### 4. PUBLIC HEARING

Jeffrey R. Anderson Real Estate, Inc. Wawa Store 7433-7451 Montgomery Road

- a. Open the Public Hearing
- b. Applicant presentation
- c. Staff report
- d. Public Comment
- e. Close the Public Hearing

#### 5. Application for Review

Jeffrey R. Anderson Real Estate, Inc. Wawa Store Stage II PMUD Preliminary Development Plan

- a. Planning Commission discussion
- b. Planning Commission recommendation to Council to approve, disapprove or modify the Stage II Preliminary Development Plan

#### 6. ADJOURNMENT

June 7th, 2024

JEFFREY R ANDERSON REAL ESTATE

Village of Silverton 6943 Montgomery Road Silverton, Ohio 45236

ATTN: Jack Cameron Village Manager

RE: Cover Letter Application for a Planned Unit Development Overlay District Amendment to the official Village of Silverton Zoning Ordinance – Stage II Preliminary Development Plan

Applicant: Jeffrey R. Anderson Real Estate, Inc.

Applicant Address: 3825 Edwards Rd., Ste 200, Cincinnati, OH

Site Location: Four parcels located at 7433, 7439, 7445, and 7449 Montgomery Rd

Mr. Cameron,

We are pleased to present the Stage II Preliminary Development Plan application adhering to the guidelines outlined in Exhibit B of the Village of Silverton's Code.

Enclosed you will find:

- 1. Civil drawings outlining the building layout, parking and circulation, landscape plan, access points, utility connections, photometrics and other details pertaining to the proposed site layout
- 2. The 10 and 25-year stormwater reports prepared by our Civil Engineer
- 3. Architectural drawings detailing the proposed floor plan and building façade
- 4. Wawa's signage drawings prepared by Blair Images
- 5. Copy of MSD's confirmation of sewer capacity

The required traffic impact study (TIS) is currently in for final review with the Village's traffic consultant, Andrea Harth. We expect to have her final determination within the next couple of weeks.

We would like to respond to some of the items we, the Applicant, missed on the Stage I requirements that were called out by Wendy Moeller of Compass Point Planning.

153.403 (D)(4)(o) - Project Team

Civil Engineer - Doug Woeste and Lucas Kimball of The Kleinger's Group Traffic Engineer - Mark Nolt of The Kleinger's Group Landscape Designer - The Kleinger's Group Architect - HFA Architects

153.403 (D)(5)(j) – "Provide a statement of the availability of other community facilities, such as schools, fire and police protection services, and cultural facilities, if any, and how these facilities are affected by this proposal"

Our proposed development will not have any adverse impact on the existing community facilities. The proposed use will be a 24/7 business that can serve the Village residents at any time of the day.

153.403 (D)(5)(f) - "Delineate the proposed parking field areas for the site"

The majority of the parking spaces on site are located behind the building following the Development Standards outlined in Section 153.402 (F) of the Village code.

Upon confirmation of receipt of the plans and preliminary acceptance that all the necessary contents are included we will begin preparing for the Stage II public hearing at a date determined by the Village Planning Commission.

If you have any questions or need anything further, please do not hesitate to ask.

Sincerely

J.R.\Anderson

Vice President of Development

Jeffrey R. Anderson Real Estate, Inc.

# SITE INFORMATION

EXISTING USE: VACANT OFFICE BUILDINGS PROPOSED USE: WAWA PUD C-1 WITH PUD OVERLAY

COMMERCIAL USE: 83,469 SF (1.916 ACRES)

LOT AREA = 83,469 SF (1.916 ACRES)

BUILDING
FOOTPRINT AREA = 6,372 SF
SIDEWALK AREA = 1,840 SF
PAVEMENT AREA = 53,076 SF
TOTAL IMPERVIOUS = 61.288 SF

IMPERVIOUS SURFACE RATIO = 73.43%

REQUIRED PARKING COMMERCIAL

 1 PER 200 SF - 6372/200 =
 32 SPACES

 1 PER PUMP - 6 x 1 =
 6 SPACES

 1 PER EMPLOYEE - 1 x 5 =
 5 SPACES


 TOTAL =
 43 SPACES

PROVIDED PARKING
STANDARD PARKING =

STANDARD PARKING = 28 SPACES
HANDICAP PARKING = 3 SPACES
FUTURE EV CHARGING = 12 SPACES
TOTAL PROVIDED = 43 SPACES

# WAWA SILVERTON PUD

# STAGE II SUBMITTAL VILLAGE OF SILVERTON HAMILTON COUNTY, OH

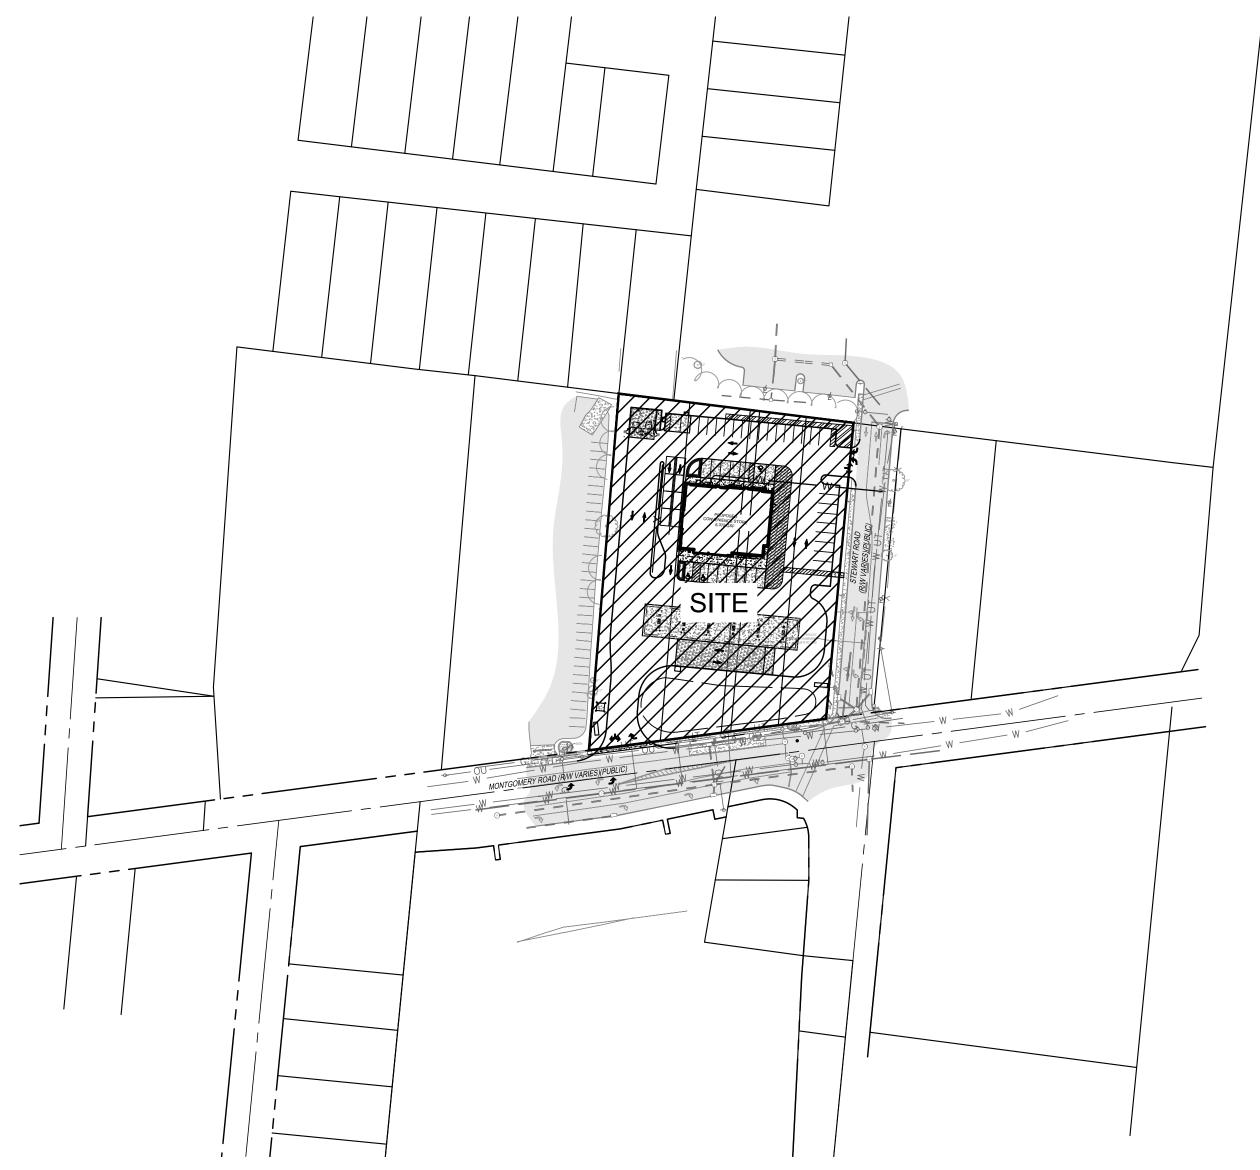

# <u>CONTACTS</u>

CABLE
TIME WARNER CABLE
11252 CORNELL PARK DRIVE
CINCINNATI, OHIO 45242
JIM O'REILLY
(513) 386-5483

ELECTRIC DUKE ENERGY 139 EAST 4TH STREET ROOM 467A CINCINNATI, OHIO 45202 TAMWA PUGH (513) 287-2240

AS
DUKE ENERGY
139 EAST 4TH STREET ROOM 460A
CINCINNATI, OHIO 45202
BRAD SEITER
(513) 287-4415

STORM & SEWER
METROPOLITAN SEWER DISTRICT
1600 GEST STREET
CINCINNATI, OHIO 45204
ROB FRANKLIN
(513) 557-7188

OWNER

JRA MVG SILVERTON LAND LLC
3825 EDWARDS ROAD

SUITE 200
CINCINNATI, OH 45209
(513) 241-5800

ENGINEER/SURVEYOR
THE KLEINGERS GROUP
6305 CENTRE PARK DRIVE
WEST CHESTER, OHIO 45069
DOUG WOESTE
(513) 274-7576

TELEPHONE
CINCINNATI BELL
221 E. 4TH STREET BUILDING 121-900
CINCINNATI, OHIO 45202
ALISON THOMAS

WATER
CINCINNATI WATER WORKS
4747 SPRING GROVE
CINCINNATI, OHIO 45232
(513) 591-7836

SILVERTON, OHIO 45236

ZONING VILLAGE OF SILVERTON 6860 PLAINFIELD ROAD



Sheet List Table

Sheet Title

TITLE SHEET

**EXISTING CONDITIONS** 

LOCATION PLAN

UTILITY PLAN GRADING PLAN

PLANTING PLAN
PLANTING DETAILS



NOTE:
UNDERGROUND UTILITIES ARE PLOTTED FROM A
COMPILATION OF AVAILABLE RECORD INFORMATION AND
SURFACE INDICATIONS OF UNDERGROUND STRUCTURES AND
MAY NOT BE INCLUSIVE. PRECISE LOCATIONS AND THE
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PERIOD OF EXCAVATION OR CONSTRUCTION ACTIVITY.



IG
6219 Centre Park Dr.
West Chester, OH 45069
513.779.7851

SEAL:

NO. DATE DESCRIPTION

SILVERTON PUD
VILLAGE OF SILVERTON

STAGE II

**HAMILTON COUNTY, OHIO** 

0 50 100 200

SHEET NAME:

TITLE SHEET

602-0008-0299

# **LEGEND**

- 5/8" IRON PIN FOUND
- AXLE FOUND
- 5/8" IRON PIN SET (KLEINGERS)
- MAG NAIL SET
- ☐ CATCH BASIN
- DOWN SPOUT
- \_\_\_\_ INLET
- YARD DRAIN
- STORM MANHOLE SANITARY MANHOLE
- CLEAN OUT
- AIR CONDITIONING UNIT

- GUY WIRE
- LIGHT POLE
- LIGHT POST
- -O- UTILITY POLE
- GAS VALVE
- FIRE HYDRANT
- WATER MANHOLE
- WATER SERVICE
- WATER VALVE TELEPHONE BOX
- SIGN (SINGLE POST)
- SIGN (DOUBLE POST)
- DECIDUOUS TREE
- CONIFEROUS TREE
- FENCE LINE
- TREE LINE OVERHEAD UTILITY
- UNDERGROUND TELEPHONE
- WATER LINE
- SANITARY SEWER
- STORM SEWER
  - *ASPHALT*
  - CONCRETE
  - GRAVEL
  - LANDSCAPING

# **SOIL NOTES**

1. UrUXC - URBAN LAND-UDORTHENTS, 0 TO 12 PERCENT SLOPES, 1.916 ACRES - 100%





<u>NOTE</u> : UNDERGROUND UTILITIES ARE PLOTTED FROM A COMPILATION OF AVAILABLE RECORD INFORMATION AND SURFACE INDICATIONS OF UNDERGROUND STRUCTURES AND EXISTENCE OR NON EXISTENCE OF UNDERGROUND UTILITIES CANNOT BE VERIFIED. PLEASE NOTIFY THE OHIO UTILITY PROTECTION SERVICE AT 811 OR 1-800-362-2764 BEFORE ANY PERIOD OF EXCAVATION OR CONSTRUCTION ACTIVITY.



**ARCHITECTURE** 513.779.7851

6219 Centre Park Dr.

West Chester, OH 45069

SURVEYING

LANDSCAPE

NO. DATE DESCRIPTION

**SILVERTON PUD VILLAGE OF SILVERTON** HAMILTON COUNTY, OHIO

**STAGE II** 

PROJECT NO: 230863.008 05-31-2024

SHEET NAME:

**EXISTING CONDITIONS** 

# PROPOSED LEGEND

HEAVY DUTY CONCRETE STANDARD DUTY CONCRETE WAWA ASPHALT PAVEMENT

CONCRETE SIDEWALK

# **LOCATION NOTES**

- 1. ALL DIMENSIONS ARE TO THE EDGE OF PAVEMENT AND/OR FACE OF CURB. UNLESS OTHERWISE NOTED.
- 2. ALL STANDARD PARKING SPACES ARE 10' X 20' EXCEPT FOR NORTHERN BAY OF PARKING
- 3. PARKING LOT STRIPING SHALL BE 4" WIDE WHITE HIGHWY-TYPE STRIPING APPLIED IN ACCORDANCE WITH THE PLAN.

# CODED NOTES

X NUMBER OF PARKING SPACES

(X-X) ADJACENT ZONING CLASSIFICATION


PROPOSED PEDESTRIAN CONNECTIVITY TO PUBLIC SIDEWALK

2 PROPOSED FULL ACCESS DRIVE ENTRANCE

3 12 FUTURE EV CHARGING SPACES

4 PROPOSED MONUMENT SIGN

PROJECT NO:

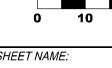

NO. DATE DESCRIPTION

SHEET NAME:

**LOCATION PLAN** 

**SILVERTON PUD** VILLAGE OF SILVERTON HAMILTON COUNTY, OHIO

STAGE II

230863,008

05-31-2024

**KLEINGERS** 


CIVIL ENGINEERING www.kleingers.com

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LANDSCAPE
ARCHITECTURE

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513.779.7851



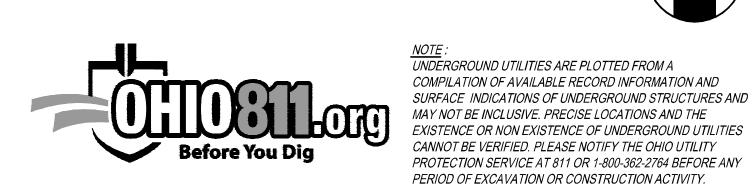

# PROPOSED LEGEND

STM SEWER PIPE

CATCH BASIN

(100)

CURB INLET

• YARD DRAIN

HEADWALL

MANHOLE

DOWNSPOUT

SANITARY SEWER PIPE


SANITARY SEWER MANHOLE

• SANITARY SEWER CLEANOUT

—— w—— WATERLINE PIPE

# CODED NOTES

- ABOVE-GROUND DRY DETENTION BASIN
- 2 DETENTION BASIN TO OUTLET TO SEWER IN MONTGOMERY ROAD
- 6" SANITARY SERVICE LINE TO TAP INTO EXISTING SANITARY MAIN IN MONTGOMERY ROAD
- 4 2" WATER SERVICE LINE

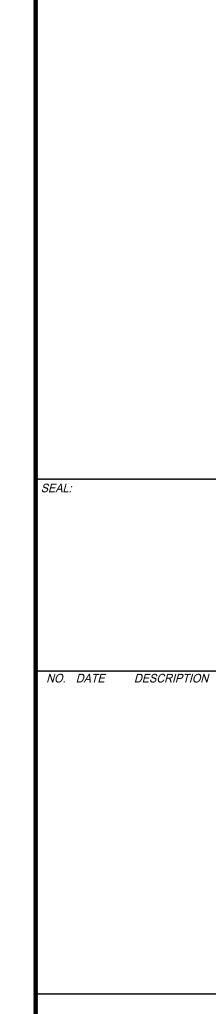

**KLEINGERS** 

CIVIL ENGINEERING www.kleingers.com

SURVEYING


LANDSCAPE
ARCHITECTURE

6219 Centre Park Dr.
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PROJECT NO:

C400

**SILVERTON PUD** 

VILLAGE OF SILVERTON HAMILTON COUNTY, OHIO

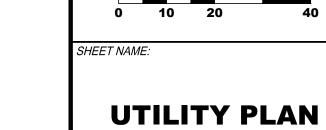STAGE II

230863.008 05-31-2024

# **GRADING LEGEND**

----- 845 ----- EXISTING MAJOR CONTOUR 

PROPOSED SWALE

# **CODED NOTES**

1) ABOVE GROUND DRY DETENTION BASIN



NO. DATE DESCRIPTION

**SILVERTON PUD** VILLAGE OF SILVERTON


STAGE II

HAMILTON COUNTY, OHIO

PROJECT NO: 230863.008 05-31-2024

SHEET NAME:

**GRADING PLAN** 

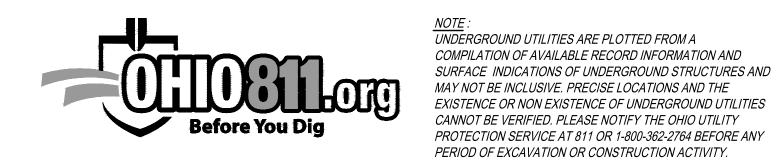

KEY	BOTANICAL NAME	COMMON NAME	SIZE	ROOT	REMARKS
DECIDUOUS TR	REES:				
ACE RUB	ACER RUBRUM	RED MAPLE	2.5" CAL. MIN.	B&B	SPACE PER PLAN
CER CAN	CERCIS CANADENSIS 'FOREST PANSY'	FOREST PANSY REDBUD	2.5" CAL. MIN.	B&B	SPACE PER PLAN
TIL COR	TILIA CORDATA	LITTLELEAF LINDEN	2.5" CAL. MIN.	B&B	SPACE PER PLAN
ZEL SER	ZELKOVA SERATA 'GREEN VASE'	GREEN VASE ZELKOVA	2.5" CAL. MIN.	B&B	SPACE PER PLAN

# **EVERGREEN TREES:**

			1	1	1
SHRUBS:					
JUN HOR	JUNIPERUS HORIZONTALIS 'WILTONI'	BLUE RUG JUNIPER	18" SP. MIN.	CONT.	PLANT 48" O.C.
ODL IAB	ODIDATA JARONIOA ILITTI E DDINIOEGGI	LITTLE BRINGESS SPIRES	400 117 1411	00117	DI ANIT COIL O

EMERALD GREEN ARBORVITAE

B&B PLANT 48" O.C.

CONT. PLANT 30" O.C.

CONT. PLANT 12" O.C.

24" HT. MIN.

#### SPIRAEA JAPONICA 'LITTLE PRINCESS' |LITTLE PRINCESS SPIREA 18" HT. MIN. CONT. |PLANT 36" O.C. TAXUS x MEDIA 'DENSIFORMIS' **DENSE YEW** PLANT 60" O.C. WEIGELA FLORIDA 'ALEXANDRA' WINE & ROSES WEIGELA 12" HT. MIN. CONT. | SPACE 60" O.C.

# HEMEROCALLIS 'STELLA DE ORO'

- 1. INCLUDE BACKFLOW PREVENTION FOR IRRIGATION LINE.
- 2. ALL TOPSOIL SHALL BE A MINIMUM 4" IN ALL SOD AREAS AND 10" 12" IN TREE, SHRUB AND GROUND COVER BEDS, INCLUDING PARKING LOT ISLAND BEDS. IT SHALL BE APPROVED BY A WAWA CONSTRUCTION REPRESENTATIVE, PRIOR TO INSTALLATION.

STELLA DE ORO DAYLILY

- 3. PLANTING BEHIND PERPENDICULAR PARKING IS TO BE LOCATED A MINIMUM OF 5' BEHIND THE CURB LINE.
- 4. ALL LANDSCAPE AND GRASS AREAS ARE TO BE HAND RAKED AND LEFT CLEAR OF ALL STONES, ROCK, CONSTRUCTION DEBRIS AND ANY UNSUITABLE MATERIALS.
- 5. ALL LANDSCAPE AND GRASS AREAS ARE TO BE IRRIGATED BY AUTOMATIC SPRINKLER SYSTEM. (SEE IRRIGATION SPECIFICATION.)

CALAMAGROSTIS ACUTIFLORA 'KARL FOERSTER' | FEATHER REED GRASS

- 7. ALL AREAS TO BE LANDSCAPED OR COVERED WITH STONE MUST BE TREATED WITH A PRE-EMERGENCE HERBICIDE (SURFLAN, DACTAL OR APPROVED EQUAL) IN ACCORDANCE WITH APPLICABLE FEDERAL, STATE REGULATIONS AND THE MANUFACTURER'S INSTRUCTIONS.
- 8. MULCH BEDS ARE TO BE DELINEATED WITH HAND OR MACHINE DUG SHOVEL EDGING.
- 9. LANDSCAPE CONTRACTOR TO SUPPLY AND INSTALL A PERVIOUS WEED BARRIER (DEWITT, DUPONT OR APPROVED EQUAL) IN ACCORDANCE WITH MANUFACTURER'S INSTRUCTIONS WITHIN ALL LANDSCAPES, INCLUDING STONE AND MULCH BEDS. ALL WEED BARRIER WILL BE OVERLAPPED A MINIMUM OF 6" AT ALL SEAMS. AT PLANT LOCATIONS, BARRIER SHOULD BE CUT IN AN "X" PATTERN SO TO ACCOMMODATE ROOT BALL AND REPLACED AFTER PLANT HAS BEEN INSTALLED.
- 10. WEED BARRIER SHALL BE IN ALL LANDSCAPE MULCH BEDS AND NOT BE VISIBLE IN AREAS DESIGNATED FOR STONE MULCH. WHEN MULCH IS CALLED FOR ADJACENT TO CURB OR SIDEWALKS, IT SHALL BE FEATHERED DOWN TO CURB LEVEL FROM A DISTANCE 24" FROM THE CURB.
- 11. ALL PROPOSED LANDSCAPING TO BE NURSERY GROWN, TYPICAL OF THEIR SPECIES OR VARIETY. THEY ARE TO HAVE NORMAL VIGOROUS ROOT SYSTEMS, FREE FROM DEFECTS AND INFECTIONS AND
- 12. ALL PROPOSED PLANTINGS SHOULD BE INSTALLED PER STANDARDS OF THE "AMERICAN ASSOCIATION OF NURSERYMEN" AND STATE NURSERY/ LANDSCAPE ASSOCIATIONS WITH REGARD TO PLANTING,
- 13. ALL PLANTING CONTAINERS AND BASKETS SHALL BE REMOVED DURING PLANTING. ALL PLANTS SHALL BE SET PLUMB AND POSITIONED SO THAT THE TOP OF THE ROOT COLLAR MATCHES OR IS NO MORE THAN TWO (2") INCHES ABOVE, FINISHED GRADE. REPLACE AMENDED BACKFILL IN 6-INCH LAYERS AND COMPACT BACKFILL TO ELIMINATE VOIDS. CONTRACTOR SHALL PROVIDE A FOUR INCH HIGH EARTHEN WATERING SAUCER ALONG THE PERIMETER OF EACH PLANTING PIT. CONTRACTOR SHALL WATER NEWLY PLANTED VEGETATION PRIOR TO MULCHING PLANTING PIT. ALL VOIDS SHALL BE
- 14. AFTER INITIAL WATERING AND PRIOR TO MULCHING, CONTRACTOR SHALL APPLY HERBICIDES AND PRE-EMERGENT HERBICIDES AS REQUIRED TO ELIMINATE ANY WEED SEEDS OR PLANTS PRESENT ON
- 15. ALL PLANTING BEDS AND PITS EXCEPT FOR LANDSCAPE ISLANDS ADJACENT TO THE BUILDING AND DESIGNATED AREA AT THE FUEL VENT STACKS, SHALL BE MULCHED WITH DOUBLE GROUND HARDWOOD MULCH AT A MINIMUM DEPTH OF 3". LANDSCAPE ISLANDS ADJACENT TO THE TANK MAT SHALL BE MULCHED WITH 1"-3" "RIVER STONE" MULCH TO AT LEAST A DISTANCE OF 5' FROM THE
- 16. TURF SPECIFICATION AND SEEDBED PREPARATION
- A. UNLESS REQUIRED FOR PARTICULAR BMP AREAS, ALL TURF ON WAWA LEASED PREMISES IS TO BE SOD. WHEN REQUIRED FOR BMP'S, SEED MIX IS TO MEET LOCAL REQUIREMENTS. SOD SHALL BE TURF TYPE TALL FESCUE AND INSTALLED ON A MINIMUM OF 4" OF TOPSOIL.
- B. APPLY LIMESTONE AND FERTILIZER ACCORDING TO SOIL TESTS OR FERTILIZER MAY BE APPLIED AT THE RATE OF 260 POUNDS PER ACRE OR 6 POUNDS PER 1000 SQUARE FEET USING 10-20-10 OR EQUIVALENT. IN ADDITION, 300 POUNDS 4-1-2 PER ACRE OR EQUIVALENT OF SLOW-RELEASE NITROGEN MAY BE USED IN LIEU OF TOPDRESSING.
- C. WORK LIME AND FERTILIZER INTO THE SOIL AS PRACTICAL TO A DEPTH OF 4-INCHES WITH A DISC, SPRING TOOTH HARROW OR OTHER SUITABLE EQUIPMENT. THE FINAL HARROWING OR DISKING OPERATION SHOULD PARALLEL TO THE GENERAL CONTOUR. CONTINUE TILLAGE UNTIL A REASONABLE UNIFORM, FINE SEEDBED IS PREPARED. ALL BUT CLAY OR SILTY SOILS AND COARSE SANDS
- D. INSPECT SEEDBED JUST BEFORE SEEDING. IF TRAFFIC HAS LEFT THE SOIL COMPACTED, THE AREA MUST BE RETILLED AND FIRMED AS OUTLINED BELOW.
- 17. PLANT MATERIAL SHALL BE GUARANTEED FOR ONE YEAR FROM THE DATE OF SUBSTANTIAL COMPLETENESS. THE CONTRACTOR SHALL REPLACE PLANTS, DEAD, UNHEALTHY, DYING OR DAMAGED THROUGH LOSS OF BRANCHES AND/OR FOLIAGE. LAWNS THAT ARE NOT IN GOOD CONDITION AT THE END OF THE GUARANTEE PERIOD SHALL BE REPAIRED UNTIL A GOOD LAWN RESULTS. IT IS UNDERSTOOD THAT THE OWNER SHALL ASSUME RESPONSIBILITY FOR WATERING ALL PLANT MATERIAL AND LAWN AREA BEGINNING WITH THE DATE OF SUBSTANTIAL COMPLETENESS.

- 2. SUBSURFACE IMPROVEMENTS SHALL BE OBSERVED. THE CONTRACTOR SHALL CONTACT THE OHIO UTILITIES PROTECTION SERVICE (OUPS) 48 HOURS PRIOR TO ANY EXCAVATION OR DIGGING TO ENSURE THE LOCATION OF UNDERGROUND UTILITIES. IT SHALL BE THE CONTRACTOR'S RESPONSIBILITY TO PROTECT SUCH UNDERGROUND UTILITIES.
- 3 ALL CONCRETE FORMS SHALL BE FIELD STAKED AND APPROVED BY OWNER'S REPRESENTATIVE PRIOR TO CONCRETE INSTALLATION
- ALL HORIZONTAL AND VERTICAL LAYOUT SHALL BE REVIEWED BY THE OWNER'S REPRESENTATIVE TO ENSURE GENERAL CONFORMANCE PRIOR TO CONSTRUCTION. 5. PROVIDE ISOLATION JOINT WHERE CONCRETE PAVING ABUTS BUILDINGS, COLUMNS, AND STRUCTURES. VERIFY COLOR OF SEALANT WITH OWNER'S REPRESENTATIVE
- CONTRACTOR SHALL NOT WILLFULLY PROCEED WITH CONSTRUCTION AS DESIGNED WHEN IT IS OBVIOUS THAT UNKNOWN OBSTRUCTIONS, AREA DISCREPANCIES AND/OR GRADE DIFFERENCES EXIST THAT MAY NOT HAVE BEEN KNOWN DURING DESIGN. SUCH CONDITIONS SHALL BE IMMEDIATELY BROUGHT TO THE ATTENTION OF THE OWNER'S REPRESENTATIVE. THE CONTRACTOR SHALL ASSUME FULL RESPONSIBILITY FOR ALL NECESSARY REVISIONS DUE TO FAILURE TO GIVE SUCH NOTIFICATIONS.
- CONTRACTOR SHALL BE RESPONSIBLE TO CONSULT WITH SITE SUPERINTENDENT, APPROPRIATE AGENCIES, AND PLANS FOR LOCATION OF ALL UNDERGROUND UTILITIES, PIPES, AND STRUCTURES. 8. CONTRACTOR TO REPORT TO ENGINEER ANY ADDITIONAL UTILITY LINES FOUND DURING CONSTRUCTION.

LIMIT OF WORK

PLANTING AREA. REFER TO LANDSCAPE PLANS

TURFGRASS SEED, TYP.

DECIDUOUS TREE, TYP

SHRUBS, TYP

PERENNIALS & ORNAMENTAL GRASSES, TYP. EXISTING TREES TO REMAIN, PROTECT IN PLACE



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**ARCHITECTURE** 513.779.7851

6219 Centre Park Dr.

West Chester, OH 45069

NO. DATE DESCRIPTION

**SILVERTON PUD VILLAGE OF SILVERTON** 

**HAMILTON COUNTY, OHIO** 

STAGE II


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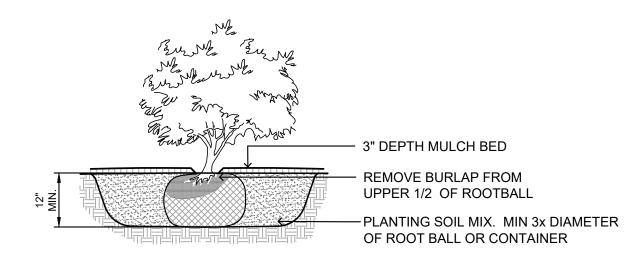
**PLANTING PLAN** 

LAWN AREA PLANTING OR MULCH AREA -EXISTING GRADE OF PLANTING AREA MULCH 3" DEPTH - VERTICAL EDGE


1 PLANTING BED / TREE PIT EDGING DETAIL N.T.S.



PERENNIAL PLANTING
N.T.S.

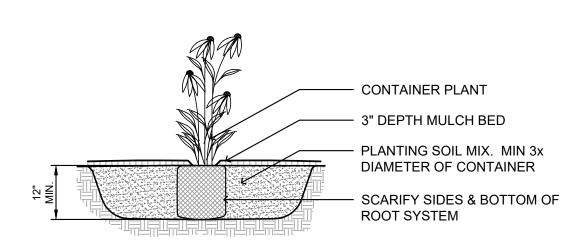


3 SHRUB PLANTING N.T.S.

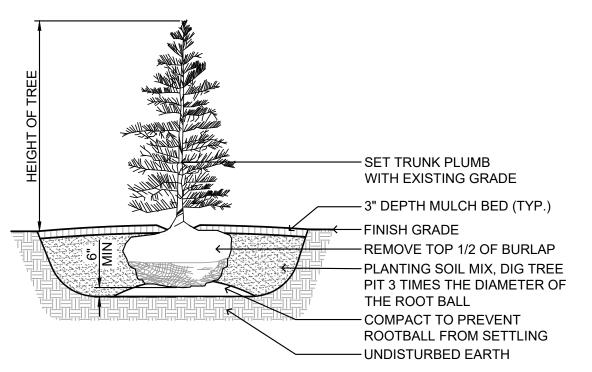

- TOP OF ROOT BALL TO BE 2"-3" ABOVE ADJACENT FINISHED GRADE. REMOVE ALL LABELS, TAGS, OR OTHER FOREIGN MATERIALS FROM LIMBS. THE AMOUNT OF PRUNING SHALL BE LIMITED TO THE MINIMUM NECESSARY TO REMOVE DEAD OR INJURED TWIGS AND BRANCHES AND TO COMPENSATE FOR THE LOSS OF ROOTS DURING TRANSPLANTING. RETAIN NORMAL SHAPE OF TREE. OWNER'S REPRESENTATIVE WILL DETERMINE AMOUNT OF PRUNING NECESSARY. PLANT TREES AT SAME GRADE AS GROWN IN THE NURSERY.
- 4. DO NOT STAKE AND GUY TREES UNLESS NEEDED FOR STABILITY BASED ON SITE CONDITIONS OR A DIRECTED BY OWNER'S REPRESENTATIVE.

**EVERGREEN PLANTING** 

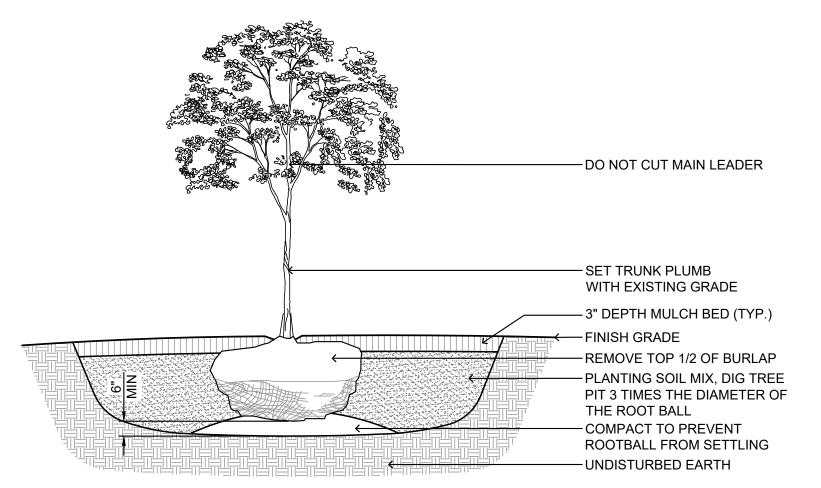


A = SPACING

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- 4. DO NOT STAKE AND GUY TREES UNLESS NEEDED FOR STABILITY BASED ON SITE
- CONDITIONS OR A DIRECTED BY OWNER'S REPRESENTATIVE. PROVIDE SLOW RELEASE WATERING DEVICE. ONE PER TREE. REFER TO SPECIFICATIONS.

DECIDUOUS TREE PLANTING

SPACING	Α	В	С	D
12"	12"	6"	10"	12"
18"	18"	8"	15	18"
24"	24"	10"	20"	24"
30"	30"	15"	25"	30"
36"	36"	18"	31"	36"
48"	48"	21"	41"	48"

B = SP/2C = SP/1.2D = SPACING

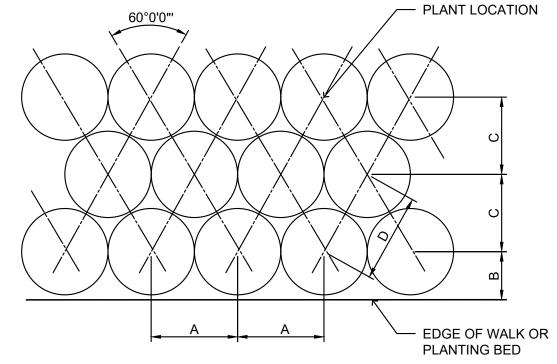

PLANT SPACING



NOTE:
UNDERGROUND UTILITIES ARE PLOTTED FROM A COMPILATION OF AVAILABLE RECORD INFORMATION AND SURFACE INDICATIONS OF UNDERGROUND STRUCTURES AND MAY NOT BE INCLUSIVE. PRECISE LOCATIONS AND THE EXISTENCE OR NON EXISTENCE OF UNDERGROUND UTILITIES CANNOT BE VERIFIED. PLEASE NOTIFY THE OHIO UTILITY PROTECTION SERVICE AT 811 OR 1-800-362-2764 BEFORE ANY PERIOD OF EXCAVATION OR CONSTRUCTION ACTIVITY.



SILVERTON PUD **VILLAGE OF SILVERTON HAMILTON COUNTY, OHIO** 

NO. DATE DESCRIPTION


**STAGE II** 

PROJECT NO: 230863.008 05-31-2024 SCALE:

SHEET NAME:

**PLANTING DETAILS** 

**L101** 

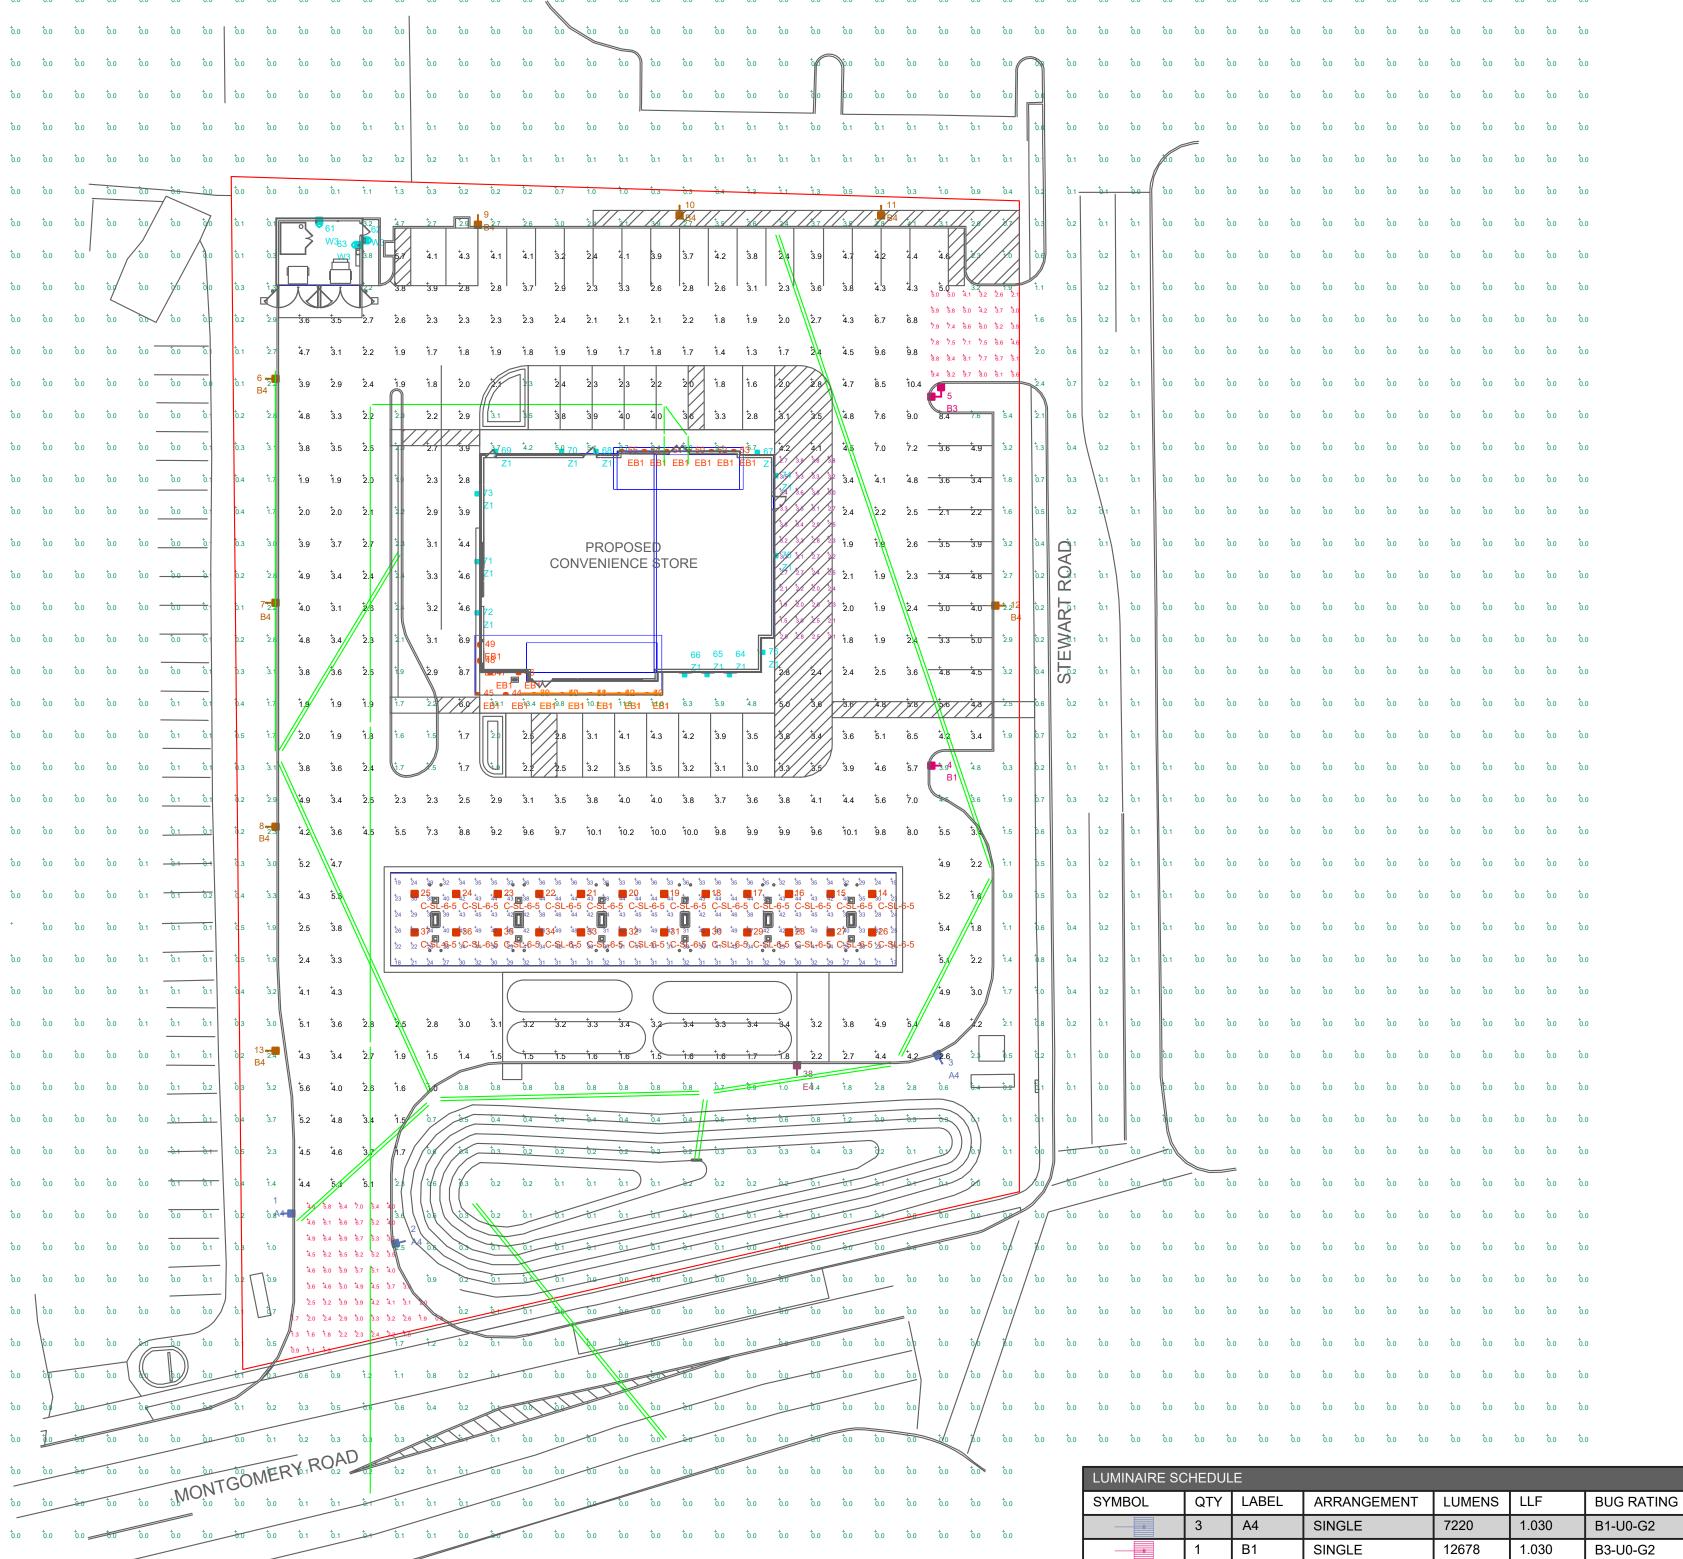

# NOTES: - ALL AREA LIGHTS ON 20 FT. POLES MOUNTED ON 6 IN. CONCRETE BASES

LUMINAIRE L	OCATION SUMMAF	RY	LUMINAIRE L	LUMINAIRE LOCATION SUMMARY						
LUM NO.	LABEL	MTG. HT.	LUM NO.	LABEL	MTG. H					
1	A4	17.5	39	EB1	10.5					
2	A4	17.5	40	EB1	10.5					
3	A4	16.21	41	EB1	10.5					
4	B1	17.5	42	EB1	10.5					
5	B3	17.5	43	EB1	10.5					
6	B4	17.5	44	EB1	10.5					
7	B4	17.5	45	EB1	10.5					
8	B4	17.5	46	EB1	10.5					
9	B4	17.5	47	EB1	10.5					
10	B4	17.5	48	EB1	10.5					
11	B4	17.5	49	EB1	10.5					
12	B4	17.5	50	EB1	10.5					
13	B4	17.5	51	EB1	10.5					
14	C-SL-6-5	18.21	52	EB1	10.5					
15	C-SL-6-5	18.21	53	EB1	10.5					
16	C-SL-6-5	18.21	54	EB1	10.5					
17	C-SL-6-5	18.21	55	EB1	10.5					
18	C-SL-6-5	18.21	56	EF1	12					
19	C-SL-6-5	18.21	57	EF1	12					
20	C-SL-6-5	18.21	58	EF1	12					
21	C-SL-6-5	18.21	59	EF1	12					
22	C-SL-6-5	18.21	60	EF1	12					
23	C-SL-6-5	18.21	61	W3	8					
24	C-SL-6-5	18.21	62	W3	8					
25	C-SL-6-5	18.21	63	W3	8					
26	C-SL-6-5	16.21	64	Z1	15					
27	C-SL-6-5	16.21	65	Z1	15					
28	C-SL-6-5	16.21	66	Z1	15					
29	C-SL-6-5	16.21	67	Z1	15					
30	C-SL-6-5	16.21	68	Z1	15					
31	C-SL-6-5	16.21	69	Z1	15					
32	C-SL-6-5	16.21	70	Z1	15					
33	C-SL-6-5	16.21	71	Z1	15					
34	C-SL-6-5	16.21	72	Z1	15					
35	C-SL-6-5	16.21	73	Z1	15					
36	C-SL-6-5	16.21	74	Z1	15					
37	C-SL-6-5	16.21	75	Z1	15					
38	E4	17.5	76	Z1	15					
39	EB1	10.5	┥  ̄ ̄ ̄	•	•					

FOOTCANDLE LEVELS CALCULATED AT GRADE USING INITIAL LUMEN VALUES								
LABEL	AVG	MAX	MIN	AVG/MIN	MAX/MIN			
CANOPY	35.96	49	17	2.12	2.88			
DELIVERY AREA	2.82	3.8	1.5	1.88	2.53			
ENTRANCES & EXIT DRIVES	4.73	9.7	0.8	5.91	12.13			
PARKING & INTERIOR DRIVE AISLES	3.70	10.4	1.0	3.70	10.40			
UNDEFINED	0.18	13.4	0.0	N.A.	N.A.			

LUMINAIRE SCHEDULE											
SYMBOL	QTY	LABEL	ARRANGEMENT	LUMENS	LLF	BUG RATING	WATTS/LUMINAIRE	TOTAL WATTS	MANUFACTURER	CATALOG LOGIC	
	3	A4	SINGLE	7220	1.030	B1-U0-G2	134	402	CREE, INC.	ARE-EDG-3MB-DA-06-E-UL-XX-700-30K	
	1	B1	SINGLE	12678	1.030	B3-U0-G2	134	134	Cree Inc.	ARE-EDG-4M-DA-06-E-UL-XX-700-57K	
<b>\$</b>	1	B3	2 @ 90 DEGREES	12678	1.030	B3-U0-G2	134	268	Cree Inc.	ARE-EDG-4M-DA-06-E-UL-XX-700-57K	
	8	B4	SINGLE	7755	1.030	B1-U0-G2	134	1072	CREE, INC.	ARE-EDG-4MB-DA-06-E-UL-XX-700-30K	
<b></b>	24	C-SL-6-5	SINGLE	10912	1.030	B3-U0-G1	101	2424	CREE, INC.	CAN-304-SL-RD-06-E-UL-XX-525-57K	
	1	E4	SINGLE	9549	1.030	B1-U0-G2	134	134	CREE, INC.	ARE-EDG-2MB-DA-06-E-UL-XX-700-57K	
	17	EB1	Single	1388	1.000	B1-U1-G0	19	323	WAC Lighting	WP-LED119-30	
	5	EF1	SSL-4_1	992	1.000	B1-U1-G0	17.444	348.88	FC Lighting	CVLWET1.5-4-3K-80CRI-1040	
>	3	W3	SINGLE	1557	1.030	B0-U0-G1	25	75	CREE, INC.	SEC-EDG-3MB-WM-02-E-UL-XX-350-57K	
	13	Z1	Single	2710	1.020	B0-U0-G1	25.31	329.03	COOPER LIGHTING SOLUTIONS - McGRAW-EDISON (FORMERLY EATON)	ISC-AF-450-LED-E1-SL4-WH-7030	

REDLEONARD ASSOCIATES
-----------------------

1340 Kemper Meadow Dr, Forest Park, OH 45240

513-574-9500 | redleonard.com

REV.	BY	DATE	DESCRIPTION

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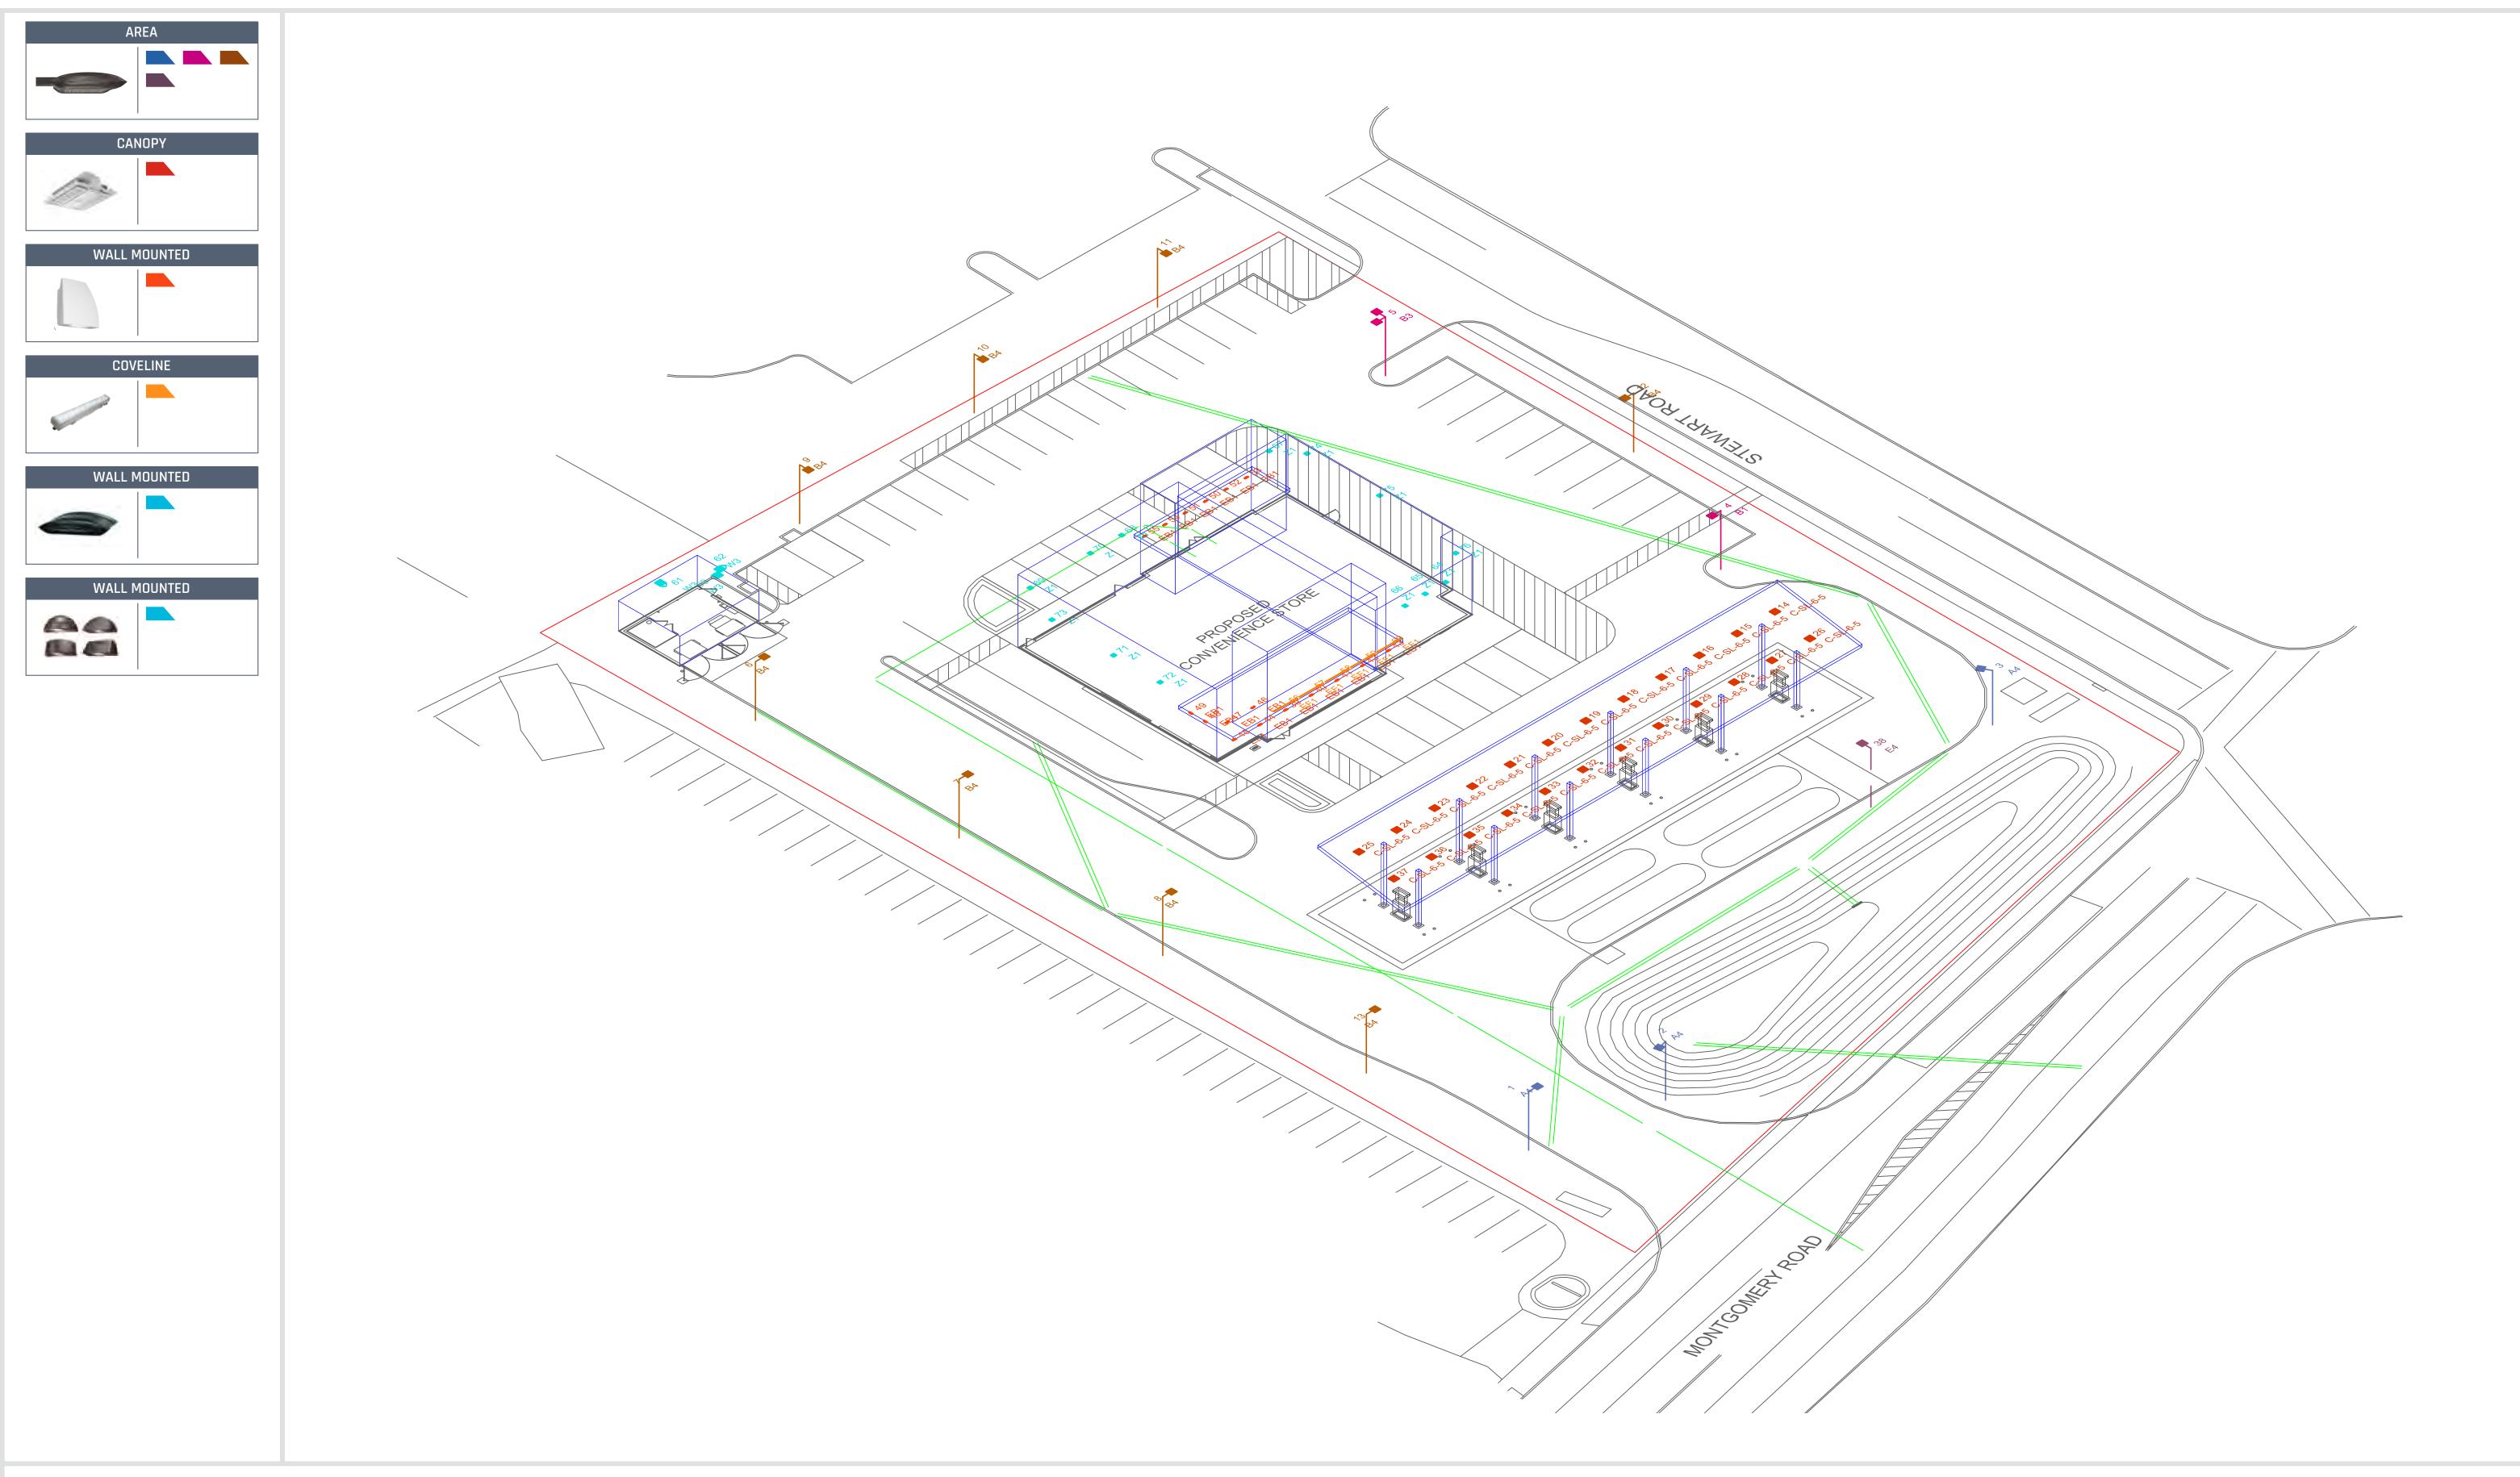
1" = 30' LMP

DWG SIZE: DATE:

D 06/12/24

PROJECT NAME:
WAWA
SILVERTON, OH.
DRAWING NUMBER:
RL-9687-S1







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PROJECT NAME:
WAWA
SILVERTON, OH
DRAWING NUMBER:
RL-9687-S1



05-31-2024

# STM Sewer Report

Stormwater Studio 2024 v 3.0.0.34

Line No.	Line	Inlet ID	Drain Area	Total Area	Inlet Time	Pipe Travel	Tc System	i Inlet	i Syst	Runoff Coeff	Incr CxA	Total C x A	Flow Rate	n-value Pipe	Line Size	Line Length	Line Slope	Invert Up	Invert Dn	Vel Ave	Capac. Full	Sf Ave	HGL Up	Grnd/Rim Elev Up	Cover Up	Cover Dn	Grnd/Rim Elev Dn	HGL Dn	
			(ac)	(ac)	(min)	(min)	(min)	(in/hr)	(in/hr)	(C)			(cfs)		(in)	(ft)	(%)	(ft)	(ft)	(ft/s)	(cfs)	(ft/ft)	(ft)	(ft)	(ft)	(ft)	(ft)	(ft)	
1	WQ-DET	WATER QU	JADIOTO/OST	R <b>W.63</b> WR	E 0.0	0.04	11.2	0.00	4.97	0.00	0.00	1.36	6.75	0.013	15	21.33	3.00	835.64	835.00	7.04	11.18	0.011	836.68	841.96	5.07	1.69	837.94	835.82	
2	100-WQ	100	0.104	0.689	10.0	0.10	11.1	5.15	4.98	0.95	0.10	0.65	3.26	0.013	12	59.99	6.08	839.29	835.64	4.60	8.78	0.009	840.06	844.06	3.77	5.32	841.96	837.11	
3	101-100	101	0.185	0.585	10.0	0.16	11.0	5.15	5.00	0.95	0.18	0.56	2.78	0.013	12	66.95	2.50	840.96	839.29	4.11	5.63	0.007	841.67	844.73	2.76	3.78	844.06	840.34	
4	102-101	102	0.251	0.399	10.0	0.15	10.8	5.15	5.03	0.95	0.24	0.38	1.91	0.013	12	40.60	1.00	841.37	840.96	3.05	3.56	0.004	842.00	845.31	2.94	2.76	844.73	841.95	
5	103-102	103	0.149	0.149	10.0	0.82	10.0	5.15	5.15	0.95	0.14	0.14	0.73	0.013	12	175.23	1.00	843.12	841.37	1.88	3.56	0.003	843.48	846.62	2.50	2.94	845.31	842.40	
6	104-WQ	104	0.000	0.742	0.0	0.25	10.9	0.00	5.01	0.00	0.00	0.70	3.53	0.013	12	85.39	1.24	836.70	835.64	4.49	3.97	0.010	837.93	842.28	4.58	5.32	841.96	837.09	
7	105-104	105	0.244	0.653	10.0	0.15	10.8	5.15	5.03	0.95	0.23	0.62	3.12	0.013	12	87.52	4.90	840.99	836.70	4.46	7.88	0.008	841.74	844.31	2.32	4.58	842.28	838.29	
8	107-105	107	0.102	0.102	10.0	0.32	10.0	5.15	5.15	0.95	0.10	0.10	0.50	0.013	12	87.22	2.80	843.43	840.99	1.58	5.96	0.003	843.73	846.93	2.50	2.32	844.31	842.12	
9	106-105	106	0.307	0.307	10.0	0.78	10.0	5.15	5.15	0.95	0.29	0.29	1.50	0.013	12	156.59	0.50	841.77	840.99	2.37	2.52	0.003	842.41	845.27	2.50	2.33	844.31	842.09	
10	108-104	108	0.088	0.088	10.0	0.41	10.0	5.15	5.15	0.95	0.08	0.08	0.43	0.013	12	59.14	0.50	837.00	836.70	0.55	2.52	0.000	838.44	840.50	2.50	4.57	842.28	838.43	

05-31-2024


# STM Sewer Report


Stormwater Studio 2024 v 3.0.0.34

Lin No.	E Line	Inlet ID	Drain Area	Total Area	Inlet Time	Pipe Travel	Tc System	i Inlet	i Syst	Runoff Coeff	Incr CxA	Total C x A	Flow Rate	n-value Pipe	Line Size	Line Length	Line Slope	Invert Up	Invert Dn	Vel Ave	Capac. Full	Sf Ave	HGL Up	Grnd/Rim Elev Up	Cover Up	Cover Dn	Grnd/Rim Elev Dn	HGL Dn	
			(ac)	(ac)	(min)	(min)	(min)	(in/hr)	(in/hr)	(C)			(cfs)		(in)	(ft)	(%)	(ft)	(ft)	(ft/s)	(cfs)	(ft/ft)	(ft)	(ft)	(ft)	(ft)	(ft)	(ft)	I
1	WQ-DET	WATER QU	JADIOTOVOS	R <b>W.63</b> WR	E 0.0	0.04	11.2	0.00	5.58	0.00	0.00	1.36	7.59	0.013	15	21.33	3.00	835.64	835.00	6.42	11.18	0.013	836.74	841.96	5.07	1.69	837.94	836.25	
2	100-WQ	100	0.104	0.689	10.0	0.09	11.1	5.75	5.60	0.95	0.10	0.65	3.66	0.013	12	59.99	6.08	839.29	835.64	5.01	8.78	0.011	840.10	844.06	3.77	5.32	841.96	837.22	
3	101-100	101	0.185	0.585	10.0	0.15	10.9	5.75	5.62	0.95	0.18	0.56	3.12	0.013	12	66.95	2.50	840.96	839.29	4.46	5.63	0.008	841.71	844.73	2.76	3.78	844.06	840.40	
4	102-101	102	0.251	0.399	10.0	0.14	10.8	5.75	5.64	0.95	0.24	0.38	2.14	0.013	12	40.60	1.00	841.37	840.96	3.06	3.56	0.004	842.12	845.31	2.94	2.76	844.73	842.02	
5	103-102	103	0.149	0.149	10.0	0.80	10.0	5.75	5.75	0.95	0.14	0.14	0.81	0.013	12	175.23	1.00	843.12	841.37	1.99	3.56	0.003	843.50	846.62	2.50	2.94	845.31	842.44	
6	104-WQ	104	0.000	0.742	0.0	0.25	10.9	0.00	5.62	0.00	0.00	0.70	3.96	0.013	12	85.39	1.24	836.70	835.64	5.04	3.97	0.012	838.24	842.28	4.58	5.32	841.96	837.19	
7	105-104	105	0.244	0.653	10.0	0.15	10.8	5.75	5.64	0.95	0.23	0.62	3.50	0.013	12	87.52	4.90		836.70		7.88	0.010		844.31	2.32	4.58	842.28	838.70	
8	107-105	107	0.102	0.102	10.0	0.31	10.0	5.75	5.75	0.95	0.10	0.10	0.56	0.013	12	87.22	2.80		840.99		5.96	0.003		846.93	2.50	2.32	844.31	842.21	
9	106-105	106	0.307	0.307	10.0	0.76	10.0	5.75	5.75	0.95	0.29	0.29	1.68	0.013	12	156.59	0.50		840.99		2.52	0.002		845.27	2.50	2.33	844.31	842.17	
10	108-104	108	0.088	0.088	10.0	0.40	10.0	5.75	5.75	0.95	0.08	0.08	0.48	0.013	12	59.14	0.50	837.00	836.70	0.61	2.52	0.000	838.89	840.50	2.50	4.57	842.28	838.88	





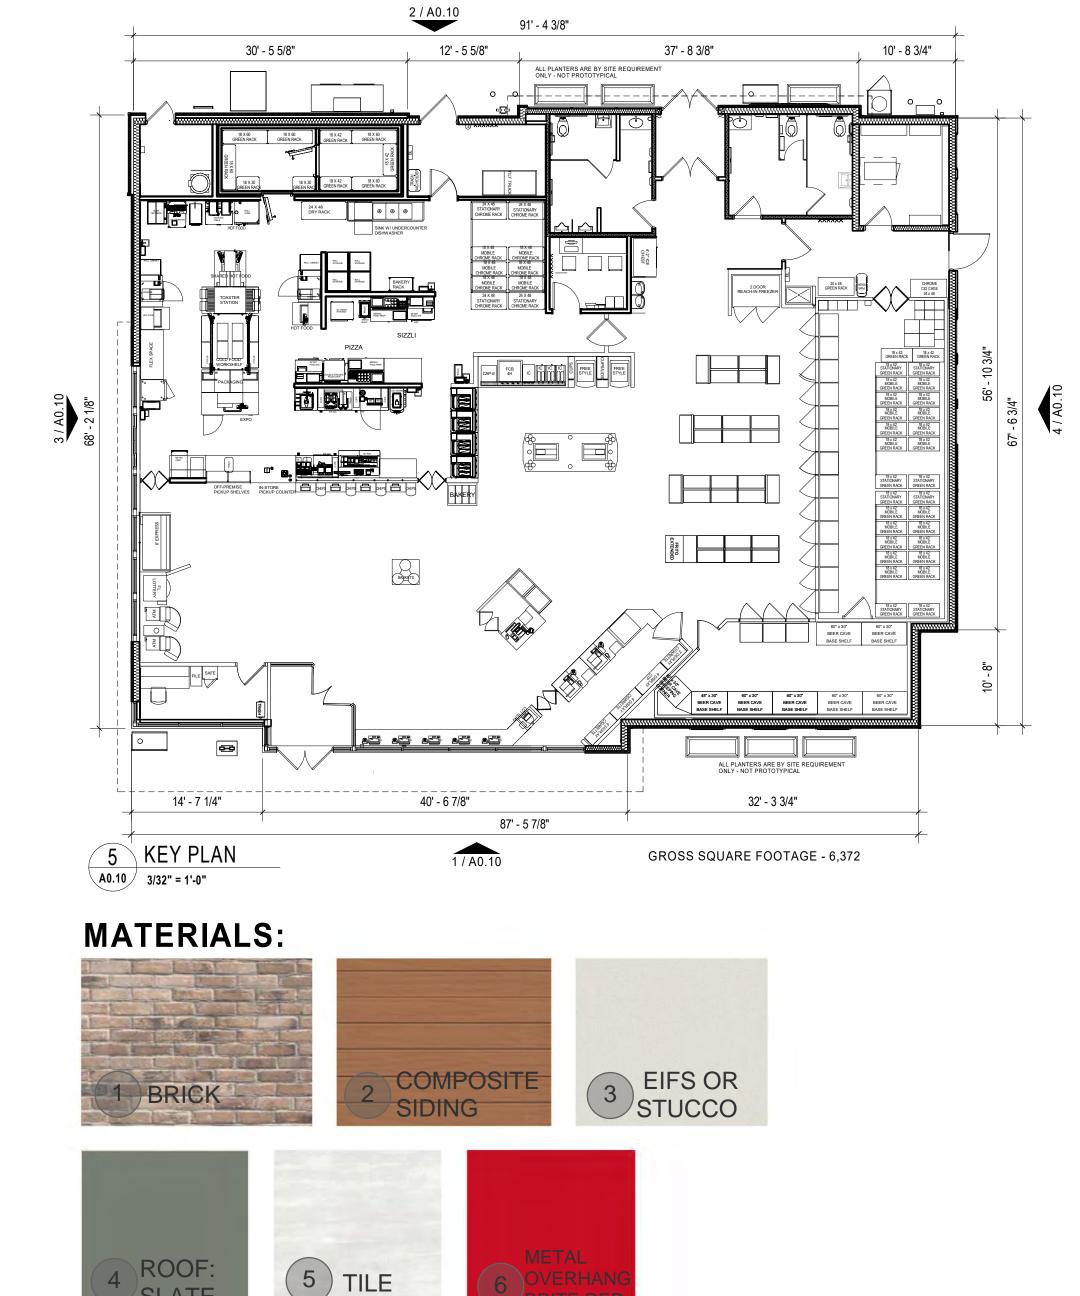

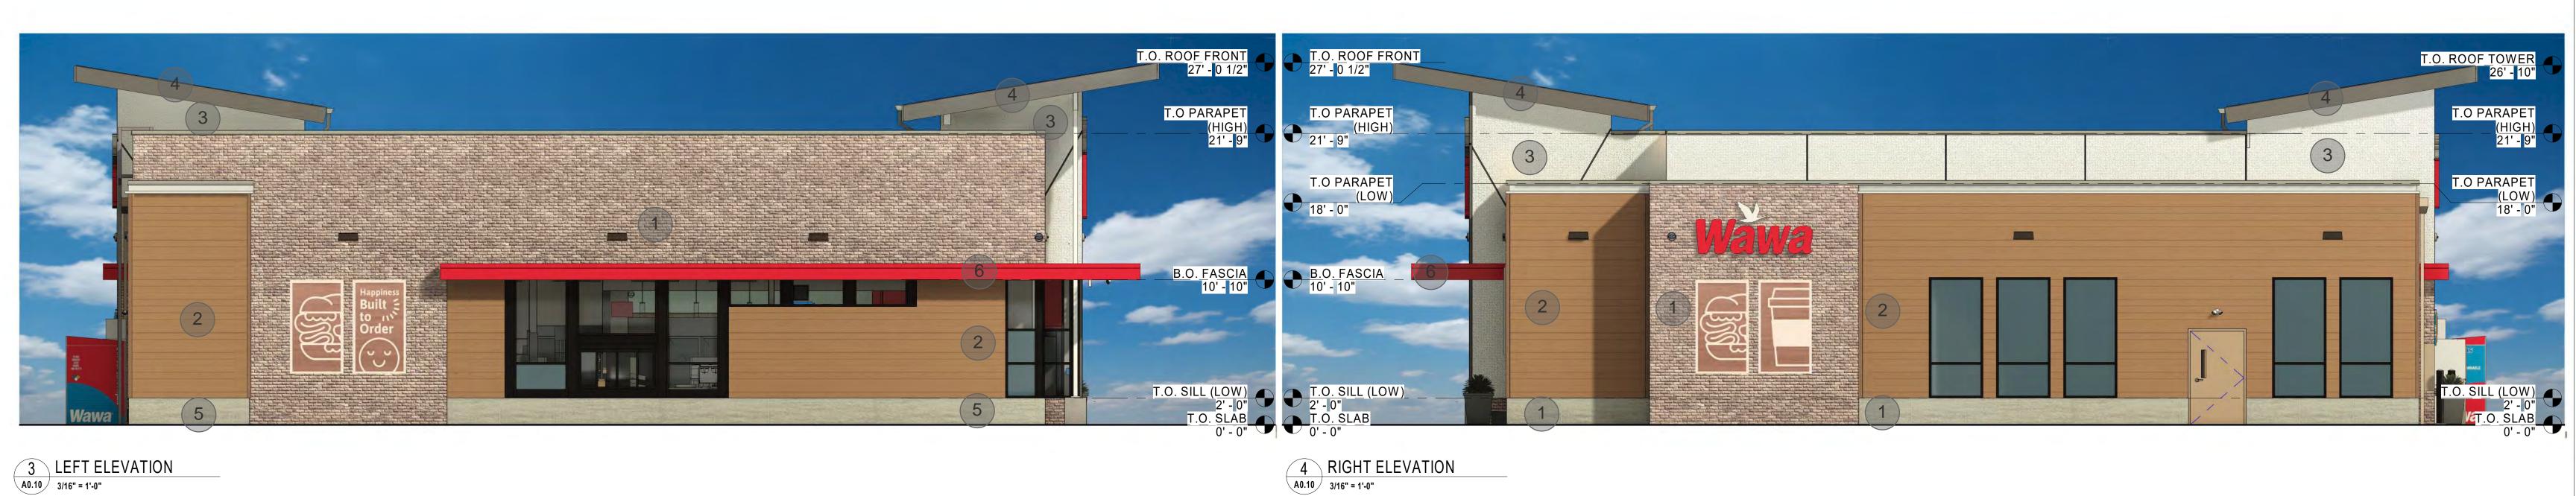



# WAWA PROTO NEXT 10

STREET ADDRESS CITY,STATE ZIP



CUSTOMER APPROVAL									
Approved	Approved as Noted	Not Approved Resubmit with Changes							
Print Name		Title							
Signature		Date							



BRAND STANDARD REVISION DATE:	All provided image elements and / or services meet the current brand revision.  The following image elements and / or services do not meet the current brand standard due to municipal code and / or specific site conditions.

# **BRANDBOOK**

CLIENT: Wawa

LOCATION: Village of Silverton,

Hamilton, OH

DATE: 6/11/2024

VARIANCE: YES

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# CONTACTS

Email: Wawa@blairimage.com

# **DOCUMENT INFO**

BLAIR PROJECT#: 111378 SALES ORDER #: TBD

DOC #: AD-TCA-111378-Hamilton-REV2

# **REVISIONS**

REV DATE DESCRIPTION

1 5/2/24 UPDATE AS PER REQUEST

6/11/24 UPDATE AS PER REQUEST





# Sign Legend

**Illuminated** Face Lit Channel letters & **Halo Lit Logo** 

Wawa 24"

Wawa 28"

Wawa 31"

Wawa 32" Wawa 35"

Wawa 38"

Wawa 44" Wawa 53"

Wawa 59"

D/F Illuminated Pylon Signs

P-50, P-75, P-100, P-150 P-200

D/F Illuminated **Monument Signs** M-50

**Directional Signs** 30" Vehicular Directional

20" Vehicular Directional 16" Vehicular Directional

D/F Illuminated

S/F Illuminated **Canopy Signs** 

S/F LED Illuminated Canopy Sign

D/F Non-Illuminated D/F Non-Illuminated **Pump Indicators Pump Spanners** 

Straight Pumps Stacked Pumps

Gas

Gas / Diesel Gas / Diesel / Ethanol Free

> **Color Material** Legend

	EXAMPLE	CLIENT COLOR	PANTONE (PMS)	VINYL; Opacity (V)	PLASTIC (PL)	PAINT (P)	TRIM CAP (TC)
1.		White		3M 7725-10 'White'; Opaque	#7328 White	White; Smooth Satin	Standard White
2.		Milky White		3M 3635-70 'Diffuser Film'; Trans.	3M 3635-70 'Diffuser Film'; Trans. #2447 Milky White		Standard White
3.		Black Gloss	PMS Process BlackC	3M 7725-12 'Black'; Opaque #2025 Opaque Black		RAL-9004 Signal Black	Standard Black
4.		Wawa Grey				Paint to Match PMS 421C	Jewelite 'Silver'
11.		Wawa Red 186	PMS 186C	3M 7725-263 "Perfect Match Red; Opaque 3m 3630-83 "Regal Red"; Trans.	#2793 Red	Paint to Match PMS 186C	Jewelite 'Red'
13.						RAL #1013 Oyster White	
16.		Kelly Green / Vivid Green	PMS 355C	3M 7725-46 'Kelly Green'; Opaque 3M 3630-156 'Vivid Green'; Trans.		Paint to Match PMS 355C	Jewelite 'Green'
17.		Olympic Blue	PMS 7461C	3M 7725-57 'Olympic Blue'; Opaque 3M 3630-57 'Olympic Blue'; Trans.		Paint to Match PMS 7461C	
20.		Limestone Cap					
21.		Masonry/Stone Fascia					
22.		#12 Brushed Aluminum - Metal Finish					
23.		Wawa Grey - Perforated Print		3M 3635-210 Perforated 'White' Vinyl			
24.		Diesel Number Sign Green	PMS 377C			Paint to Match PMS 377C	

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Wawa Village of Silverton, Hamilton, OH

STORE# C-06495


Issue Date: 5/1/2024 Drawn By: Mike C.

Rev: 2

Date: 6/11/2024 Doc #: AD-WAW-111378-Hamilton-REV2

Blair Project #: 111378 Page 3 | Blair Sales Order #: TBD Blair Image Elements 5107 Kissell Avenue Altoona, PA 16601 P: (814) 949.8287 blairimage.com



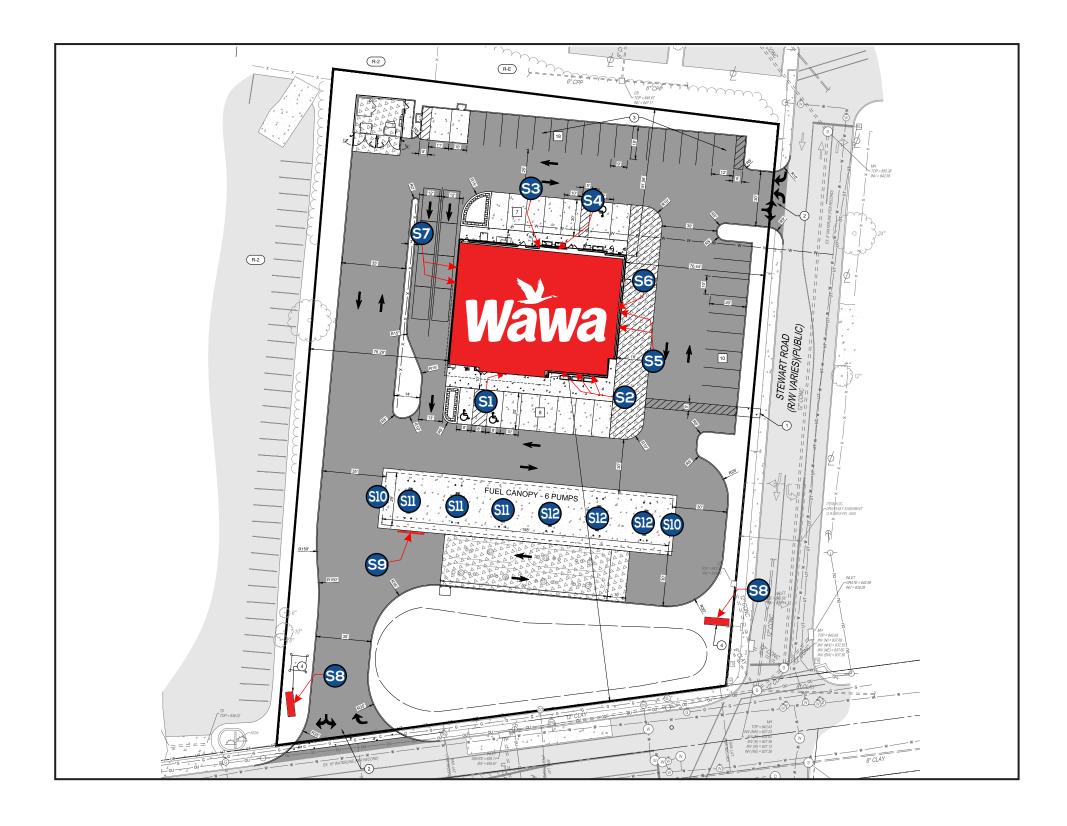

SIGN ID	IGN ID DESCRIPTION	
S1	WAWA CHANNEL LETTERS WITH GOOSE	1
S2	WALL PANELS (SET OF 3)	1
<b>S</b> 3	WAWA CHANNEL LETTERS WITH GOOSE	1
S4	WELCOME PANEL	1
S5	WALL PANELS (SET OF 2)	1
S6	WAWA CHANNEL LETTERS WITH GOOSE	1
<b>S7</b>	WALL PANELS (SET OF 2)	1
S8	DOUBLE FACE MONUMENT SIGN	2
S9	GAS CANOPY SIGN	1
S10	CANOPY SPANNERS	2
S11	PUMP INDICATORS	6
S12	PUMP INDICATORS	6

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Wall Signs	ALLOWED total sf	CURRENTLY INSTALLED	PROPOSED	CODE	VARIANCE (Y/N)
S1 Front Elevation Ch. Letters	60 SF		120.8 SF	MAX ALLOWANCES:  ** as a corner lot: 2 sign max	Υ
S2 Front Elevation Art Panels	ARCHITECTURAL / ARTISTIC FEATURES		84 SF	allowed NTE 1sf per If of shortest	Υ
S3 Rear Elevation Ch. Letters	60 SF 0 SF		67.71 SF	frontage, max 60sf Signs may be externally illuminated only	Y
S4 Rear Elevation Welcome Sign			20.83 SF		Υ
S5 Rear Elevation Art Panels	ARCHITECTURAL / ARTISTIC FEATURES		56 SF		Υ
S6 Side Elevation Ch. Letters	0 SF		42.5 SF		Υ
S7 Rear Elevation Art Panels	ARCHITECTURAL / ARTISTIC FEATURES		56 SF		Υ
Free Standing SIgns	ALLOWED total sf	CURRENTLY INSTALLED	PROPOSED	CODE	VARIANCE (Y/N)
\$8 - CUSTOM D/F ILLUMINATED MONUMENT SIGN (OPTION 1)	50 SF		54.70 SF		Y
S8 - CUSTOM D/F ILLUMINATED MONUMENT SIGN (OPTION 1)	50 SF		54.70 SF	1 freestanding sign allowed NTE 1 sq ft p/linear foot of frontage / Max: 25 sq ft each face; 50sf Max height from base is 5ft	Y
\$8 - CUSTOM D/F ILLUMINATED MONUMENT SIGN (OPTION 2)	50 SF		61.75 SF	**LED PRICERS NOT ALLOWED** Manual gasoline service station pricing boards must not exceed	Y
S8 - CUSTOM D/F ILLUMINATED MONUMENT SIGN (OPTION 2)	50 SF		61.75 SF	8sf.	Y
Canopy	ALLOWED total sf	CURRENTLY INSTALLED	PROPOSED	CODE	VARIANCE (Y/N)
S9 Gas Canopy Channel Letters	30 SF		9.02 SF	Canopy square footage NTE 30sf aggregate	N
S10 Spanner	20.98 SF		7.9 SF	Other information signage on pumps is allowed provided it	N
S10 Spanner	20.98 SF		7.9 SF	doesn't exceed 4sqf	N
S11 Pump Id's	4/ea		1/ea		N
S12 Pump Id's	4/ea		1/ea		N

# **COMMENTS**

Site is in the Village of Silverton and is currently zoned C-1 Neighborhood

Permits will take approximately 3-4 weeks to procure and will be valid for one year Variances are allowed but are not guaranteed and may take 4+ months to obtain approval as the length of time is unknown.

WALL SIGNS:

Corner lots in the C-1 Districts having frontage on more than one public street shall have a [SEE CODE] however, there shall be no increase in the number of ground mounted or free standing signs allowed.

- No projecting sign in the C-1 Districts shall be internally illuminated.
- In addition to the materials and color requirements set forth herein, projecting signs located in the C-1 District shall not be designed in a square or rectangular

Projecting signs: The bottom of any projecting sign shall be a minimum of eight feet above any side walk and 15 feet above any driveway. \_\_\_\_\_

#### FREESTANDING:

- SETBACK: (d) All signs shall be set back at least 7ft from street frontage and 10' from any side yard lot line.

**DIRECTIONALS:** 

NTE 3sf / 3ft OAH may not be internally illuminated



C-06495





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Blair Project #: 111378
Blair Sales Order #: TBD



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Rev: 2

Date: 6/11/2024 Doc #: AD-WAW-111378-Hamilton-REV2

Page 7 Blair Project #: 111378
Blair Sales Order #: TBD

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Rev: 2 Date: 6/11/2024 Doc #: AD-WAW-111378-Hamilton-REV2
Blair Project #: 111378
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Rev: 2


Date: 6/11/2024 Doc #: AD-WAW-111378-Hamilton-REV2

Page 9 Blair Sales Order #: TBD





**NOTE: THE CONSTRUCTION IS THE SAME BUT THE LETTERS WILL NOT BE ILLUMINATED. EXTERNAL ILLUMINATION** TO BE DETERMINED AND PROVIDED BY THE GC.

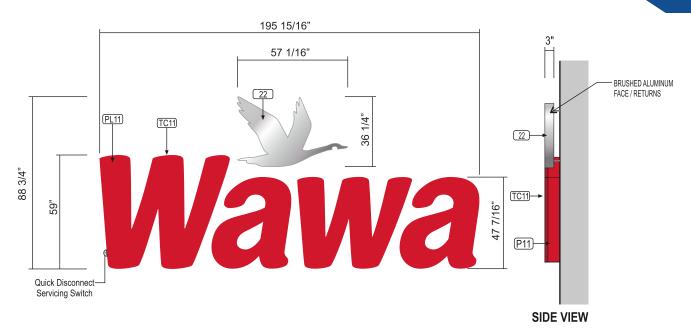

59" NON ILLUMINATED CHANNEL LETTERS W/ GOOSE LOGO

SCALE: NTS

STANDARD SPECS - SEE COLOR SPECIFICATION LIBRARY SQ.FT. of ONE(1) GEOMETRIC SHAPE = 120.8 SQ FT

#### WALL MATERIAL:


to vary per site


#### INSTALL:


Logo: Thru bolted w/ 2" stand off from wall Letters Thru bolted flush; all w/ min 3/8" dia all thread into approved blocking; spacers provided for logo painted to match wall

#### QUANTITY:

(1) one set required

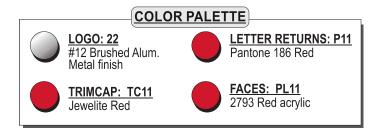

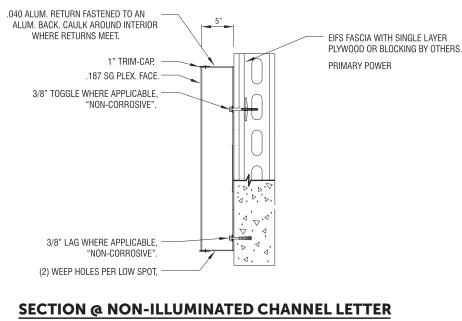

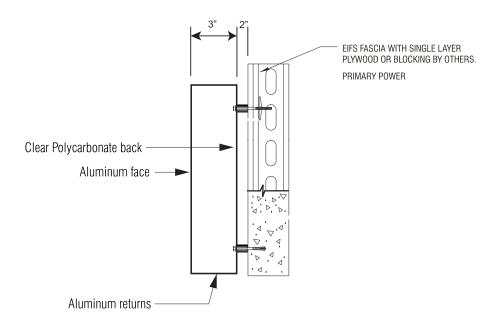

**SECTION @ NON-ILLUMINATED GOOSE LOGO** 

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Wawa Village of Silverton, Hamilton, OH

STORE# C-06495

Issue Date: 5/1/2024 Drawn By: Mike C.


Rev: 2

Date: 6/11/2024 Doc #: AD-WAW-111378-Hamilton-REV2

Blair Project #: 111378 Page 10 Blair Sales Order #: TBD **Blair Image Elements** 5107 Kissell Avenue Altoona, PA 16601 P: (814) 949.8287 blairimage.com



QTY: 1 SET OF 3

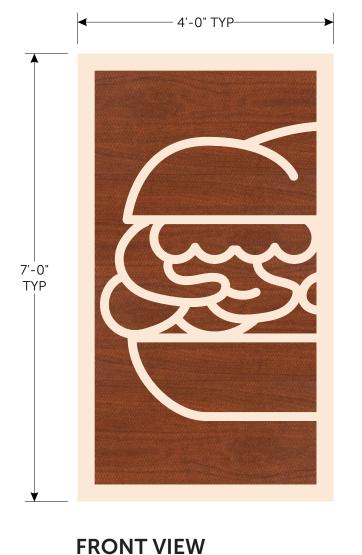

SCALE: 1"=18"

# Order

SCALE: 1"=18"


Happiness

Built





**ISOMETRIC VIEW** 

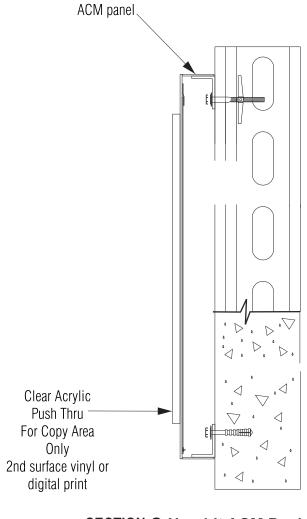


Boarder to be digitally printed

on same level as wood grain. Copy to be acrylic push thru.

# **CLEANING CRITERIA**

28 SQ.FT.

Pressure Wash Acceptable. If using 25° tip and over. Use ONLY mild detergent soap and water.

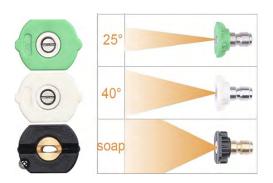

**FRONT VIEW** 

SCALE: 1"=18"

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28 SQ.FT.

# **SECTION @ Non Lit ACM Push Thru**

SCALE: NTS



Wawa Village of Silverton, Hamilton, OH

STORE# C-06495

Issue Date: 5/1/2024 Drawn By: Mike C.


Rev: 2

28 SQ.FT.

Date: 6/11/2024 Doc #: AD-WAW-111378-Hamilton-REV2 Blair Project #: 111378

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NOTE: THE CONSTRUCTION IS THE SAME BUT THE LETTERS WILL NOT BE ILLUMINATED. EXTERNAL ILLUMINATION TO BE DETERMINED AND PROVIDED BY THE GC.

44" NON ILLUMINATED CHANNEL LETTERS W/ GOOSE LOGO

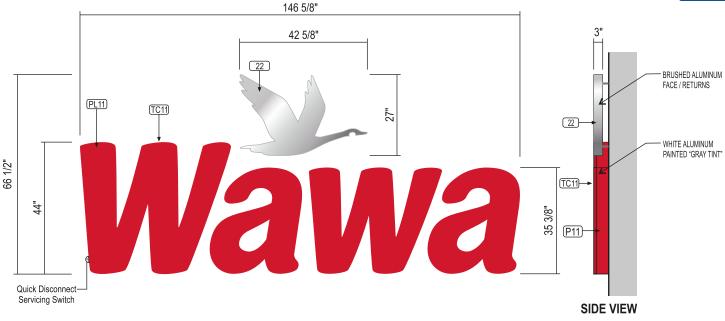SCALE: 3/8"=1'-0"

STANDARD SPECS - SEE COLOR SPECIFICATION LIBRARY SQ.FT. of ONE(1) GEOMETRIC SHAPE = **67.71 SQ. FT.** 

#### WALL MATERIAL:


to vary per site


#### **INSTALL**:

Logo: Thru bolted w/ 2" stand off from wall
Letters Thru bolted flush; all w/ min 3/8" dia all thread
into approved blocking; spacers provided for logo painted to match wall

#### QUANTITY:

(1) one set required

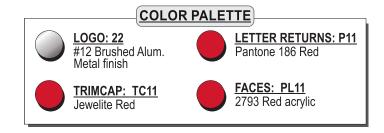

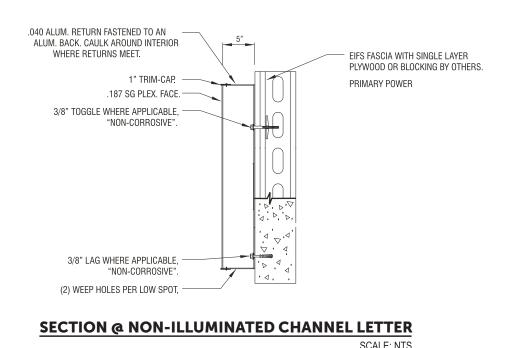

Aluminum face

Aluminum returns

SECTION @ NON-ILLUMINATED GOOSE LOGO

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**Wawa** Village of Silverton, Hamilton, OH

STORE # C-06495

Issue Date: 5/1/2024 Drawn By: Mike C. Rev: 2 Date: 6/2

Date: 6/11/2024
Doc #: AD-WAW-111378-Hamilton-REV2

Clear Polycarbonate back

Blair Project #: 111378
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Blair Sales Order #: TBD

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EIFS FASCIA WITH SINGLE LAYER

PRIMARY POWER

PLYWOOD OR BLOCKING BY OTHERS.




Boarder to be digitally printed on same level as wood grain. Copy to be acrylic push thru.

SCALE: 1"=14" 20.83 SQ.FT.

# **CLEANING CRITERIA**

Pressure Wash Acceptable. If using 25° tip and over. Use ONLY mild detergent soap and water.



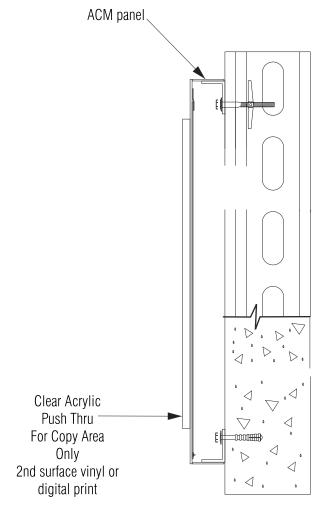

**SECTION @ Non Lit ACM Push Thru** 

SCALE: NTS



Wawa Village of Silverton, Hamilton, OH

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Rev: 2


Date: 6/11/2024 Doc #: AD-WAW-111378-Hamilton-REV2

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IMAGE ELEMENTS

QTY: 1 SET OF 2




### **ISOMETRIC VIEW**

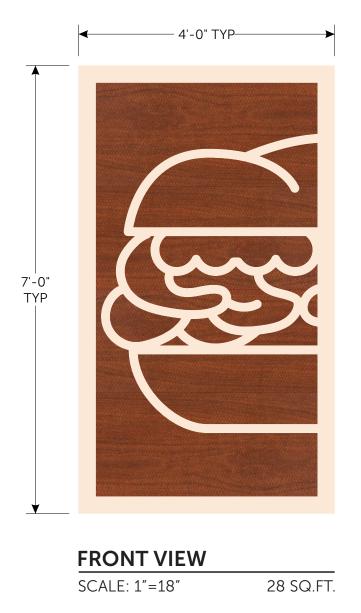

# **FRONT VIEW**

SCALE: 1"=18"

28 SQ.FT.

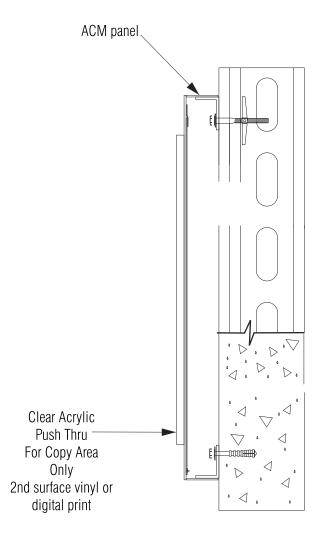

# **CLEANING CRITERIA**

Pressure Wash Acceptable. If using 25° tip and over. Use ONLY mild detergent soap and water.



**SECTION @ Non Lit ACM Push Thru** 

SCALE: NTS



Wawa Village of Silverton, Hamilton, OH

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Rev: 2


Date: 6/11/2024 Doc #: AD-WAW-111378-Hamilton-REV2

Boarder to be digitally printed on same level as wood grain. Copy to be acrylic push thru.

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**NOTE: THE CONSTRUCTION IS THE SAME BUT THE LETTERS WILL NOT BE ILLUMINATED. EXTERNAL ILLUMINATION** TO BE DETERMINED AND PROVIDED BY THE GC.



#### X 35" NON ILLUMINATED CHANNEL LETTERS W/ GOOSE LOGO

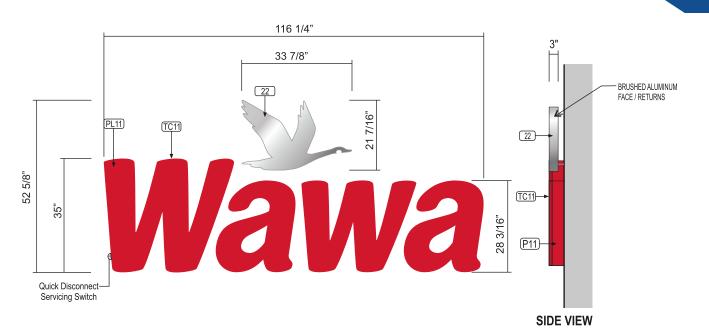SCALE: 3/8"=1'-0"

STANDARD SPECS - SEE COLOR SPECIFICATION LIBRARY SQ.FT. of ONE(1) GEOMETRIC SHAPE = 42.5 SQ FT

#### WALL MATERIAL:


to vary per site


#### INSTALL:

Logo: Thru bolted w/ 2" stand off from wall Letters Thru bolted flush; all w/ min 3/8" dia all thread into approved blocking; spacers provided for logo painted to match wall

#### QUANTITY:

(1) one set required

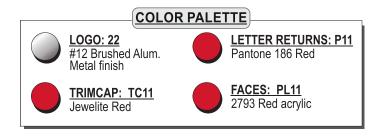

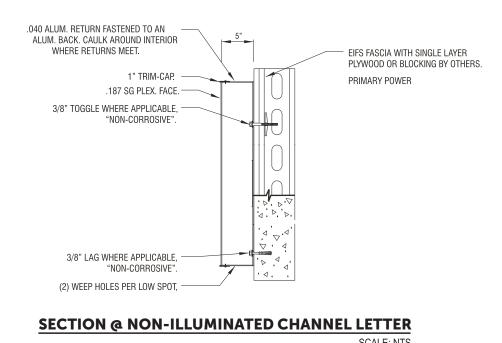



EIFS FASCIA WITH SINGLE LAYER PLYWOOD OR BLOCKING BY OTHERS. PRIMARY POWER Clear Polycarbonate back Aluminum face -

**SECTION @ NON-ILLUMINATED GOOSE LOGO** 

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Wawa Village of Silverton, Hamilton, OH

STORE# C-06495

Issue Date: 5/1/2024 Drawn By: Mike C.

Rev: 2

Date: 6/11/2024 Doc #: AD-WAW-111378-Hamilton-REV2

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QTY: 1 SET OF 2




### **ISOMETRIC VIEW**



**FRONT VIEW** 


SCALE: 1"=18"

28 SQ.FT.

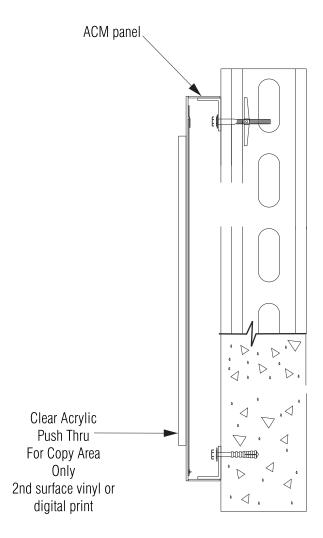

# **CLEANING CRITERIA**

Pressure Wash Acceptable. If using 25° tip and over. Use ONLY mild detergent soap and water.

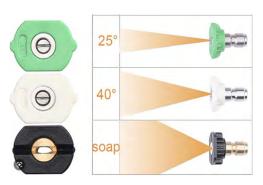

**SECTION @ Non Lit ACM Push Thru** 

SCALE: NTS



Wawa Village of Silverton, Hamilton, OH

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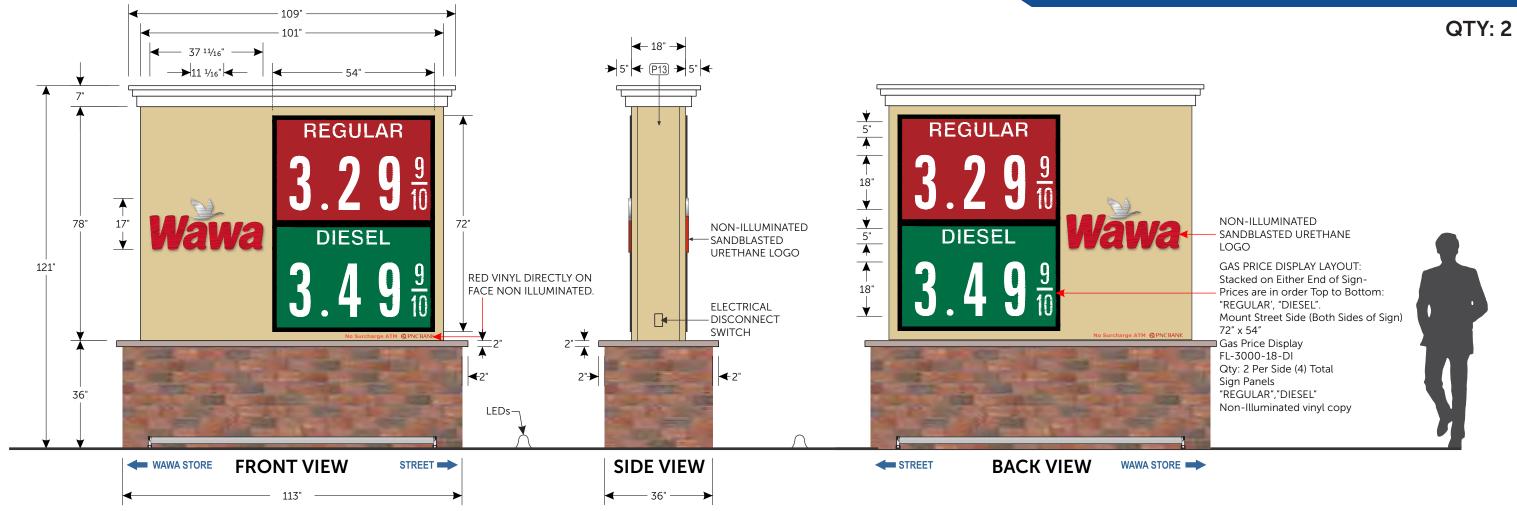
Boarder to be digitally printed

on same level as wood grain. Copy to be acrylic push thru.

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blairimage.com






#### 18"/2 PRODUCT M-50 D/F EXTERNALLY ILLUMINATED MONUMENT SIGN (54.70 SQ.FT.)

STANDARD SPECS SEE COLOR SPECIFICATION LIBRARY

SCALE: 3/8"=1'

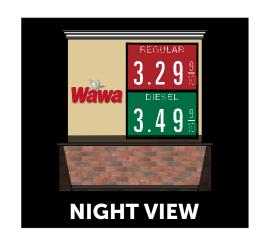







Translucent





Opaque



'Brushed Aluminum







Smooth Satin





Stone/Masonry Fascia Base By Others



Wawa Village of Silverton, Hamilton, OH

STORE# C-06495

Issue Date: 5/1/2024 Drawn By: Mike C.


Date: 6/11/2024 Doc #: AD-WAW-111378-Hamilton-REV2

Blair Project #: 111378 Page 17 | Blair Sales Order #: TBD



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#### 18"/3 PRODUCT M-50 D/F EXTERNALLY ILLUMINATED MONUMENT SIGN (61.75 SQ.FT.)

SCALE: 1" = 40" STANDARD SPECS SEE COLOR SPECIFICATION LIBRARY

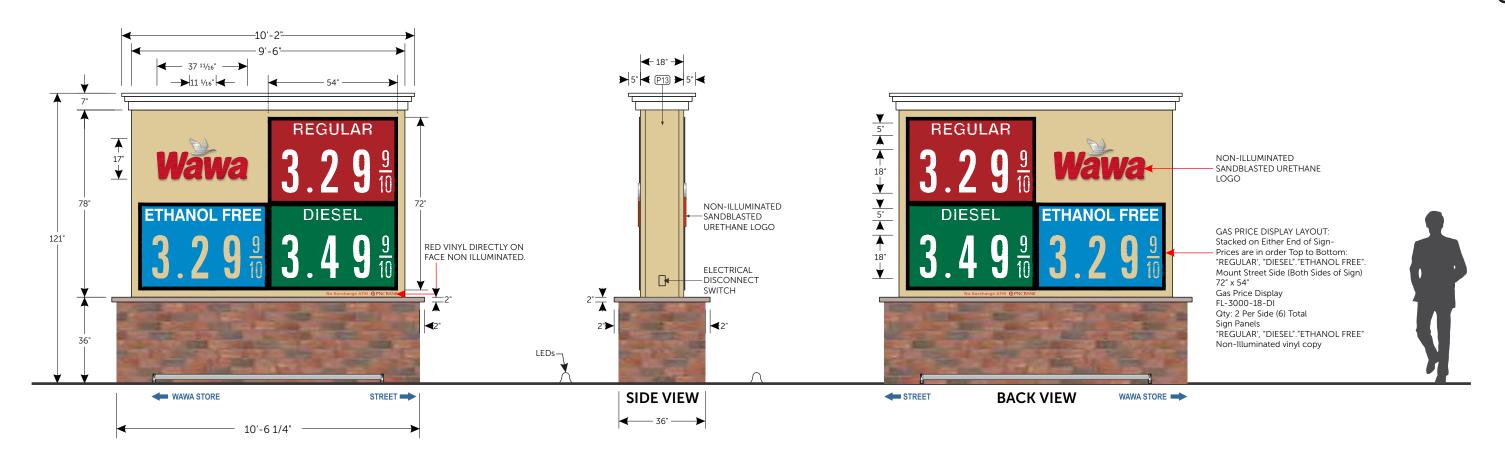




P11

Painted to match

PMS 187C

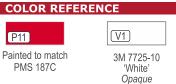



Translucent





Opaque



'Brushed Aluminum





Smooth Satin



By Others



By Others

Wawa Village of Silverton, Hamilton, OH

STORE# C-06495

Issue Date: 5/1/2024 Drawn By: Mike C.


Rev: 2 Date: 6/11/2024

Doc #: AD-WAW-111378-Hamilton-REV2 Blair Project #: 111378 Page 18 Blair Sales Order #: TBD

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#### **5" DEEP FRONT NON-ILLUMINATED LETTERS & LOGO (ON 4" X 7" EXTRUDED RACEWAY) - RIGHT SIDE**

9.02 SQ.FT.

SCALE: 3/4=1'-0"

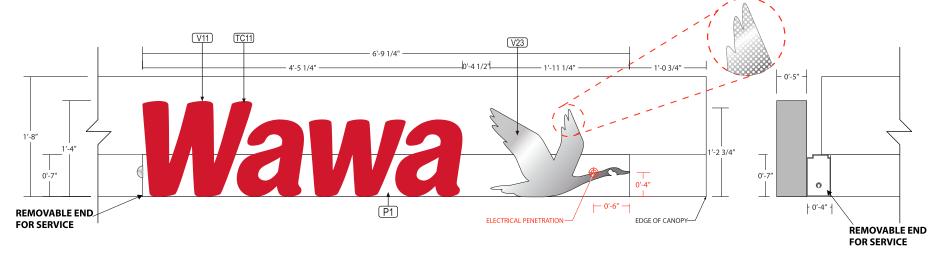STANDARD SPECS - SEE COLOR SPECIFICATION LIBRARY END OF RACEWAY TO BE REMOVABLE TO ALLOW FOR SERVICING.

Paint to PMS 186 C Jewelite 'Red'

Trim Cap

#2793 Red

Acrylic

3M 3635-210 Printed to match

(P1) PAINTED WHITE SMOOTH SATIN

#2447 Milky White Acrylic



**NOTE: THE CONSTRUCTION IS THE SAME BUT THE LETTERS WILL NOT BE ILLUMINATED. EXTERNAL ILLUMINATION** TO BE DETERMINED AND PROVIDED BY THE GC.

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Wawa Village of Silverton, Hamilton, OH

STORE# C-06495

Drawn By: Mike C.

Rev: 2 Date: 6/11/2024


Doc #: AD-WAW-111378-Hamilton-REV2

Blair Project #: 111378 Page 19 | Blair Sales Order #: TBD

# **Blair Image Elements**


5107 Kissell Avenue Altoona, PA 16601 P: (814) 949.8287 blairimage.com



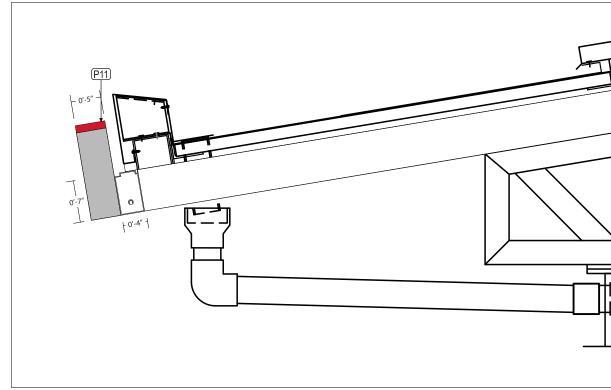



SELF-CONTAINED FLUSH MOUNT CANOPY SIGN (SIDE VIEW)

SCALE: 3/4"=1'-0"

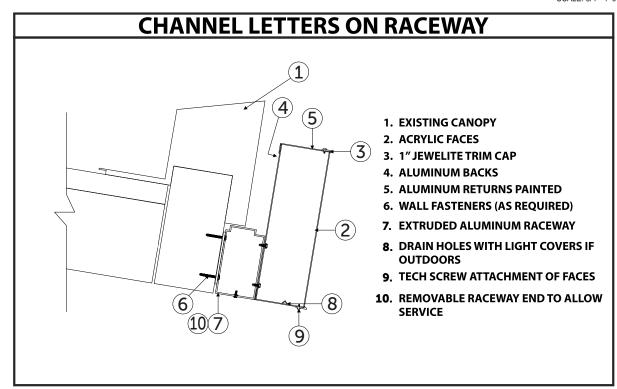

SCALE:1 1/2"=1'-0"

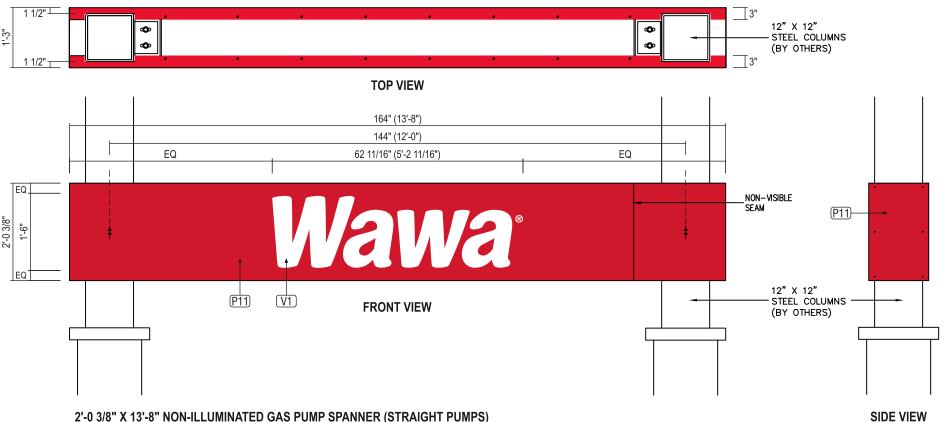

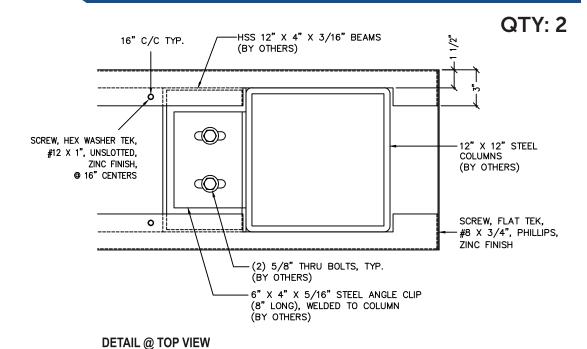

2'-0 3/8" X 13'-8" NON-ILLUMINATED GAS PUMP SPANNER (STRAIGHT PUMPS)

STANDARD SPECS - SEE COLOR SPECIFICATION LIBRARY



**CANOPY ELEVATION (STRAIGHT PUMPS)** 

SCALE:1/8"=1'-0"


SCALE:1/2"=1'-0"

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Paint to match 3M 7725-10 'White' PMS 186 C Opaque

AREA/WEIGHT SIGN SQUARE FOOTAGE: 27.8 sq. ft. ESTIMATED SIGN WEIGHT: 120 Lb.

TOLERANCE: ± 1/16" ON ALL DIMENSIONS

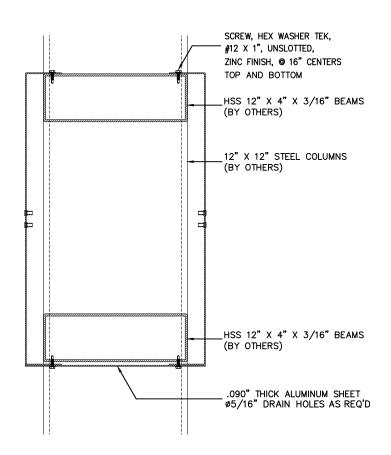

**SECTION @ SPANNER SIGN** 

SCALE:1 1/2"=1'-0"



Wawa Village of Silverton, Hamilton, OH

STORE# C-06495

Issue Date: 5/1/2024 Drawn By: Mike C.


Rev: 2 Date: 6/11/2024

Doc #: AD-WAW-111378-Hamilton-REV2 Blair Project #: 111378 Page 20 Blair Sales Order #: TBD

Blair Image Elements 5107 Kissell Avenue Altoona, PA 16601 P: (814) 949.8287 blairimage.com





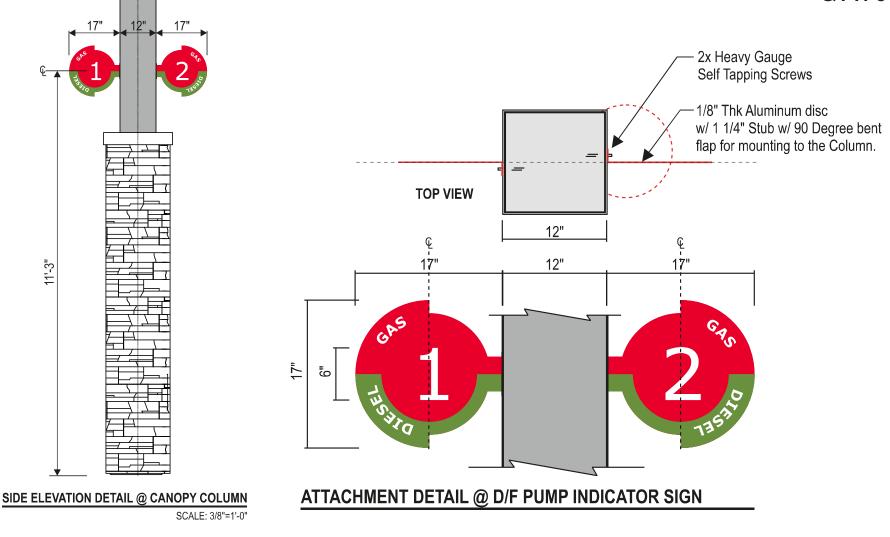

# DETAIL @ WHITE VINYL PUMP NUMBERS - GAS & DIESEL

1'-5"

DETAIL @ D/F PUMP INDICATOR SIGN - GAS & DIESEL

ALUMINUM FACES PAINTED RED & GREEN. WHITE VINYL COPY & NUMBERS.

FONT STYLE: VERDANA

8 1/2"

9

5 1/2"

QTY: NUMBERS 1 - 16 x 2 (for D/F SIGNS) WHITE VINYL NUMBERS. FONT STYLE: VERDANA

SCALE: 3/4"=1'-0"

#### \* NOTE: CONFIRM PUMP NUMBER SEQUENCE PRIOR TO MANUFACTURING

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8 1/2"

V1

SCALE: 1 1/2"=1'-0"


P11

Paint to match

PMS 377C GREEN

Paint to match PMS 186 C



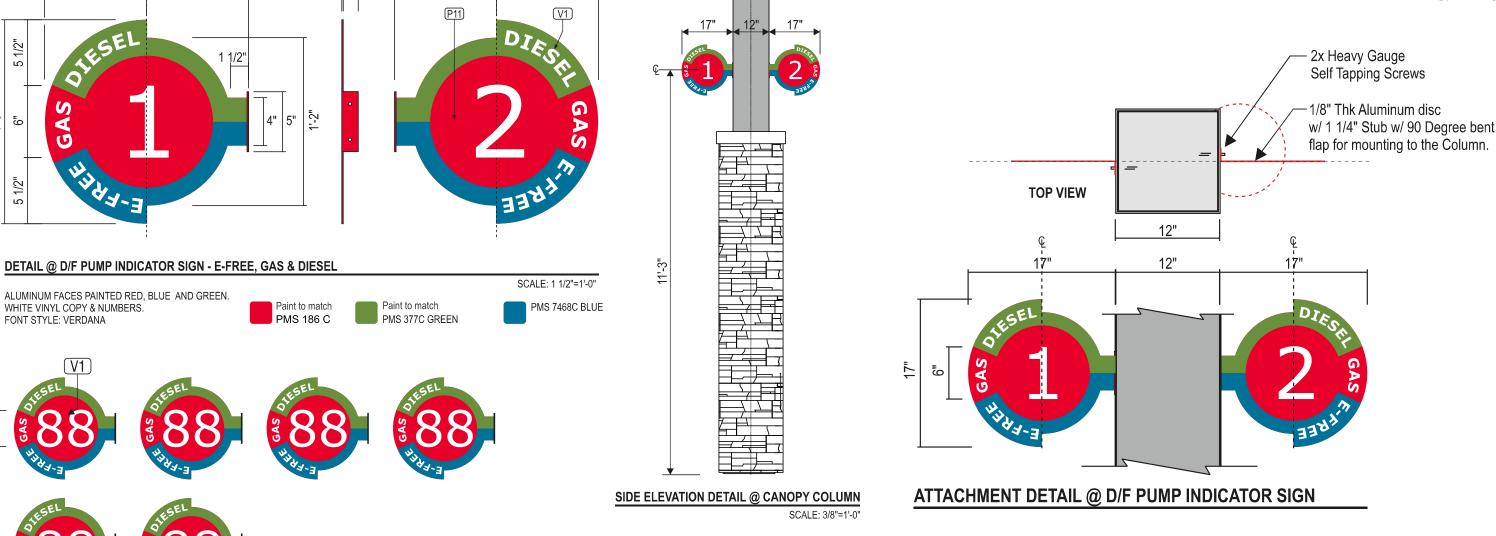

#### DETAIL @ WHITE VINYL PUMP NUMBERS - E-FREE, GAS & DIESEL

1'-5"

8 1/2"

QTY: NUMBERS 1 - 16 x 2 (for D/F SIGNS) WHITE VINYL NUMBERS. FONT STYLE: VERDANA

SCALE: 3/4"=1'-0"

1'-5"

8 1/2"

#### \* NOTE: CONFIRM PUMP NUMBER SEQUENCE PRIOR TO MANUFACTURING

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# **JOBSITE CODE OF CONDUCT and BASIC EXPECTATIONS**

SUBCONTRACTOR recognizes and agrees, that while it is an Independent Contractor from BLAIR and OWNER, SUBCONTRACTOR is an extension of, and representing, the OWNER as perceived by the general public. SUBCONTRACTOR, and any and all Approved Subcontractors, shall abide by the following Code of Conduct while performing WORK for BLAIR to meet the collective professionalism required by SUBCONTRACTOR, BLAIR and OWNER.

- No profanity.
- No offensive clothing.
- No smoking unless in designated area away from the work area.
- No loud music.
- No Horseplay.
- Be respectful and courteous of the location and work site, customers, patrons and the general public.
- Notify location/site manager upon arrival to and departure from site/location.
- Review work and safety plan with location/site Manager.
- Mark off work areas with cones and caution tape.
- Use proper PPE (Personal Protective Equipment).
- Maintain a clean, organized and orderly work site.
- Dispose of trash properly; recycle as able.
- Do not bring pets or animals to work site.

Active site locations are not to be left unbranded at completion of daily work schedules. Temporary Banner(s) are to be installed at designated location(s).

# INSTALLATION INSTRUCTIONS

All necessary hardware to be provided by installer.

Contact your Blair Image Elements' Project Manager for full product installation instructions.

Installation instructions will also be provided on the product crate upon delivery. They will typically be in a plastic sleeve attached directly to the product crate.

# COMMUNICATION and WORK IN PROCESS and **COMPLETION PHOTOGRAPHS**

SUBCONTRACTOR and any and all Approved Subcontractors, will at a minimum, provide routine communication to BLAIR Project Manager with respect to WORK at the site/location, including but not limited to:

- confirmation text within 15 minutes of arrival at site/location
- mid-day text providing WORK status
- text within 15 minutes of leaving site providing completed WORK status and related photographs of completed WORK and work in process
- completion photographs of lit branding elements requires either night time photographs or photographs showing illuminated LEDs or bulbs.

This communication is required by OWNER who routinely expects daily updates to WORK progress at any given site/location.

SUBCONTRACTOR and any and all Approved Subcontractors, will not begin WORK at site/location, or leave WORK site/location without first communicating with BLAIR Project Manager.

In the event there are questions, concerns, or additional direction is needed, SUBCONTRACTOR and any and all Approved Subcontractors, while on site/location will contact BLAIR Project Manager over the site/location for assistance.

Upon completion of WORK, SUBCONTRACTOR and any and all Approved Subcontractors, will obtain written acceptance of completed WORK from site/location Manager and provide a copy of such to BLAIR.

# SAFETY CRITERIA

All installers working for Blair must complete the Blair Safety Certification Program.

SAFETY CRITERIA / GENERAL INSTALLATION INFO

All Blair subcontractors working on a petroleum site must have a valid API Certification, follow the established guidelines set forth by API as well as follow any local, state, or federal laws.

- Perform a Pre-Task Job Safety Analysis.
- Understand how and where to obtain First-Aid and medical treatment, including CPR.
- Use the proper level of PPE per the assigned task.
- Only use tools that are in safe working order before using them.
- Always use tools for their intended purpose and never over their safe working limit.
- Employees operating vehicles must conform to all DOT requirements as well as API regulations.
- Use proper fall arrest equipment.
- Understand the requirements for working at height on a job site.
- Properly barricade the work area from the public in accordance with Section 8 of the API guidelines.
- Only competent and trained people using approved equipment in a manner in accordance with Section 10 of the API guidelines should perform lifting duties.

**Examples of Equipment Include:** Personal Protective Equipment, Barricade, Crane, Hoist, Bucket Truck, Scissor Lift, Ladder, Vinyl Applicators (Squeegee or Application Liquid), Welder/Torch, and Hand Tools/Power Tools

#### SERVICE CONTACT

Service Contact: (814) 283-2177

Service Hours: 8:00 am to 4:30 pm EST, Monday -

website: www.blairimage.com/support

email: service@blairimage.com

After hours / holiday emergencies, call (800) 563-9598



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April 4, 2024

Casey Abney
Jeffrey R. Anderson Real Estate, INC.
3825 Edwards Road
Suite 200
Cincinnati, OH 45209

Subject: Request for Availability of Sewer Service APPROVAL

Convenience Store - (40) Employees & (6) Gas Islands

Auditor's Parcel Numbers 0602-0008-0196 to -0198, -0204, & -0207

7433 Montgomery Road

Silverton

APD Number HMD2400120

Dear Mr. Abney,

Your sewer availability request for the above-referenced property has been processed and approved. Sanitary sewer service is available via connection to the existing public sewer in Montgomery Road, subject to the following requirements and conditions:

- 1. All plans and construction shall comply with the latest edition of the MSD Rules and Regulations which govern the design, construction, maintenance, operation, and use of sanitary and combined sewers. This document can be downloaded from the MSD website at <a href="https://msdgc.org/doing-business-with-us/msd-rules-and-regulations/">https://msdgc.org/doing-business-with-us/msd-rules-and-regulations/</a>.
- 2. Special considerations should be made to protect MSD's infrastructure during construction. Any damage to the sanitary sewer is to be remediated at the contractor's expense. Once the connection point to the sewer has been uncovered, MSD's on-site inspector will need to verify any necessary repairs to the sanitary sewer that must be completed before the work can occur.
- 3. In instances where the overflow rim of the lowest plumbing fixture in any proposed structure is below the rim elevation of the next upstream manhole in the sewer system to which the proposed structure is connected, a backwater valve shall be installed per Section 614 of the MSD Rules and Regulations.
- 4. This development shall be subject to the requirements of Article XV of the MSD Rules and Regulations, which requires filing the appropriate Waste Discharge Permit Application as a condition of obtaining sewer service. These forms can be downloaded from the MSD website at <a href="https://msdgc.org/customers/industrial-and-commercial-customers/">https://msdgc.org/customers/industrial-and-commercial-customers/</a>. Additional information can be obtained by contacting the MSD Division of Industrial Waste at 513.557.7000.
- 5. This development shall be subject to the requirements of Article XV of the MSD Rules and Regulations, which requires filing the appropriate Sewer Use Customer Application for Food Service as a condition of obtaining sewer service. These forms can be downloaded from the MSD website at <a href="https://msdgc.org/customers/food-service-customers/">https://msdgc.org/customers/food-service-customers/</a>.
- 6. The proposed development is serviced by sewers known to surcharge above the basement floor elevations of other properties in the immediate vicinity during periods of wet weather. Per Section 1204 of the MSD Rules and Regulations, the property owner shall be responsible for taking the necessary precautions to provide adequate protection from flooding for any new building sewer connections to the public sewer system.
- 7. A tap permit must be obtained per Section 1201 of the MSD Rules and Regulations. After the tap

permit is issued, the sewer contractor must contact MSD WWE Inspections at 513.244.5537 or MSDWWEInspections@cincinnati-oh.gov for sewer inspection.

- 8. All sewer tappers making building sewer connections to the MSD sewer system shall be licensed and bonded by MSD per Section 1212 of the MSD Rules and Regulations.
- 9. The person to whom a tap permit or special permit is issued shall be responsible for obtaining any additional permits required to open-cut any public street, road, or highway from the appropriate public authority having jurisdiction per Section 1210 of the MSD Rules and Regulations.
- 10. Roof drains, foundation drains, cooling water, swimming pool water, or other clean water connections to the sanitary sewer system are prohibited per Section 401 of the MSD Rules and Regulations. A notarized affidavit stating that the sanitary wastewater is free of such clear waters must be submitted to MSD before a tap permit will be issued. Hamilton County Department of Public Works should be consulted regarding the stormwater collection, detention, and conveyance requirements.

The conditional availability of sewer service as described in this letter is effective until one year from the date of this letter and may be extended for one additional year per Article V, Section 510 of the MSD Rules and Regulations. Time extension requests may be made within thirty (30) days of the expiration date of this application through the MSD website at the following link: REQUEST for AVAILABILITY of SEWER SERVICE Form Webpage. Subsequent extension requests may or may not be granted depending on the availability of sewer credits, the hydraulic capacity of the sewer system, and/or other factors that may affect MSD's ability to accept additional sanitary flows into our sewer system.

This determination of sewer availability is based on the best information available at this time to the Metropolitan Sewer District of Greater Cincinnati. It is subject to modification or revocation resulting from regulatory action taken by the United States Environmental Protection Agency, the State of Ohio Environmental Protection Agency, federal consent decrees, or other judicial action ordered by federal courts of the United States Government or the courts of the State of Ohio.

If you have any questions, please call William Weinheimer at 513.882.8464 or me at 513.882.8468.

Sincerely,

Robert Franklin

MSD-ODOT Liaison | MSD Availability | MSD Utility Review Metropolitan Sewer District of Greater Cincinnati (MSD) Cell: 513.882.8468 | Email: Rob.Franklin@cincinnati-oh.gov

RF: ww

c: Availability File, Silverton









# **M**EMORANDUM

**DATE:** JULY 5, 2024

**SUBJECT:** WAWA TRAFFIC STUDY REVIEW

PREPARED BY: Andrea Harth, PE, PTOE, RSP

TEC Engineering, Inc.

**Prepared For:** The Kleingers Group

TEC has reviewed the Traffic Impact Study dated 4/5/24. The traffic study should be updated based on the following comments.

Existing/Background Volumes/Trip Generation/Trip Distribution:

**Previously Approved** 

#### Analysis:

Approved

#### Recommendations & Findings:

Due to queuing from the signal along with the number of left turning entering vehicles, TEC recommends the Montgomery Road Access be limited to right-in, left-in, right-out only. This would restrict the left turns out of the site, and those cars would need to use the signal to turn left from the site onto eastbound Montgomery Road. The queue analysis shows that eastbound traffic queues past the access during the AM and PM Peaks making the left out an unsafe movement, especially given the proximity to the signal.

In addition, TEC recommends a right turn lane be installed at the access point. The turn lane warrant is for a 4-lane road, which fits Montgomery Road. However, given the shared thru-left lane at the Steward Road signal, the lane distribution is not even. More westbound thru cars use the right lane than a traditional 2 lane approach. Again, given the close proximity to the intersection and the proportion of westbound cars in the right lane, a short deceleration lane is recommended for the right turns into the Montgomery Road access.